


A

## SECTION 3

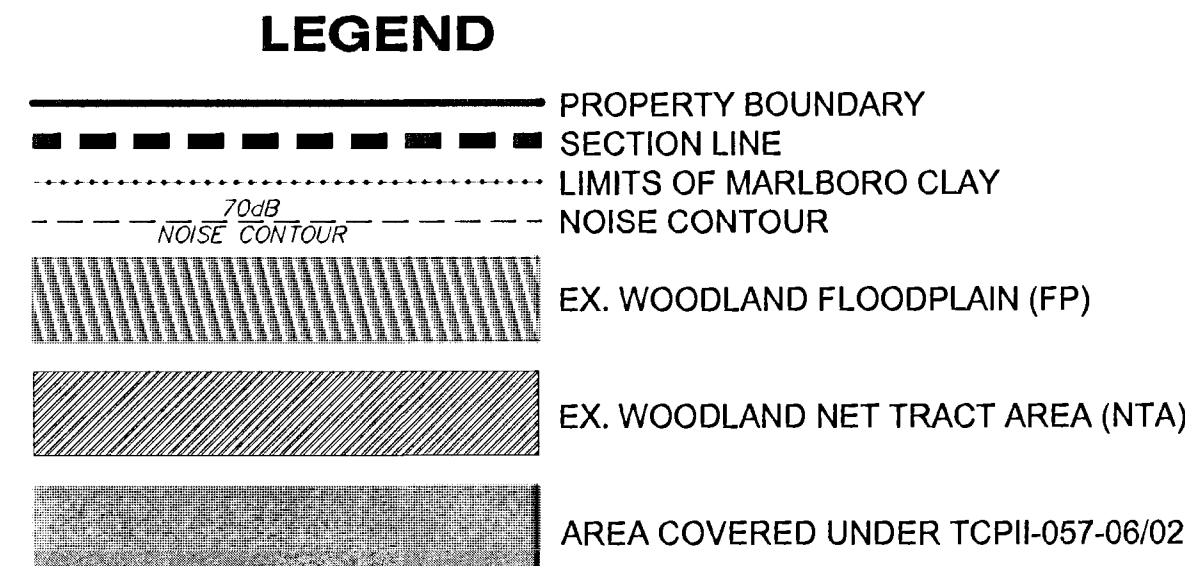

\*PREVIOUSLY PART OF SMITH HOME FARM, NOW SEPARATE OWNERS/APPLICANT, SHOWN & COMPUTED FOR CONSISTENCY WITH NRI 006-05.

WOODLAND CLEARED (C-NTA)		1A1
LABEL	SECTION	AREA
31	3	0.53
<b>TOTAL</b>		<b>0.53</b>

WOODLAND RE/AFFORESTATION (WRA) ①		
LABEL	SECTION	AREA
1	3	3.28
2	3	0.89
<b>TOTAL</b>		<b>4.17</b>

Section	Gross Tract Area	100-Yr Floodplain (FP)	Net Tract Area (NTA)	Ex. Woodland (NTA)	Ex. Woodland (FP)	Woodland Cleared Net-Tract (C-NTA)	Woodland Cleared Floodplain (C-FP)	Woodland Cleared Off-Site (C-OS)	Woodland Cleared PMA (C-PMA)	Woodland Preserv. Area (WPA)	Woodland Reforest. Area (WRA)	Woodland Retained/ Not Cleared (WR-NC)	Woodland Retained/ Assumed Cleared (WR-AC)
3	27.85	0.00	27.85	0.53	0.00	0.53	0.00	0.00	0.00	0.00	4.17	0.00	0.00

<b>TCPII REVISION TRACKING CHART</b>	
01	REVISED OVERALL WORKSHEET TO REFLECT CHANGES IN 1A AND 1B AND ADD AFFORESTATION LOCATED IN FUTURE SECTION. SEE SHEET 2.
02	REVISED LAYOUT AND WORKSHEETS TO REFLECT SECTION 3 LAYOUT CHANGES. SEE SHEETS 2, 4-7, 10.




TITLE  
TYPE II TREE  
CONSERVATION  
PLAN  
SECTION 3  
COVER SHEET

SHEET NO. 1 OF 10



**PROFESSIONAL CERTIFICATION:**  
I HEREBY CERTIFY THAT THESE DOCUMENTS WERE PREPARED OR APPROVED BY ME, AND THAT I AM A DULY REGISTERED LANDSCAPE ARCHITECT UNDER THE LAWS OF THE STATE OF MARYLAND, LICENSE NO. 1079.  
EXPIRATION DATE: JULY 14, 2016.

### KEY PLAN

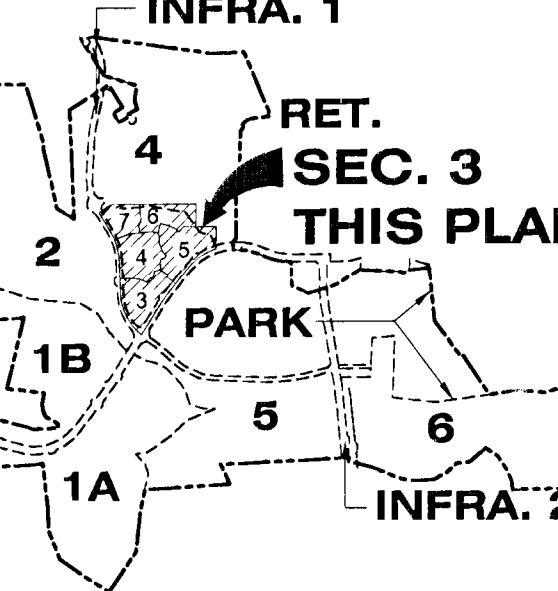

SCALE

**AS-SHOWN**

[illegible]

No.	DATE	BY	Description
<b>REVISIONS</b>			

DRAWN BY	ERW
APPROVED BY	TA
CHECKED BY	LRB
DATE	SEPTEMBER 2014

TITLE  
TYPE II TREE  
CONSERVATION  
PLAN  
SECTION 3  
COVER SHEET

DEWBERRY JOB NO. 50038403

SHEET NO. 1 OF 10




## F

E**B**

- A

## 2



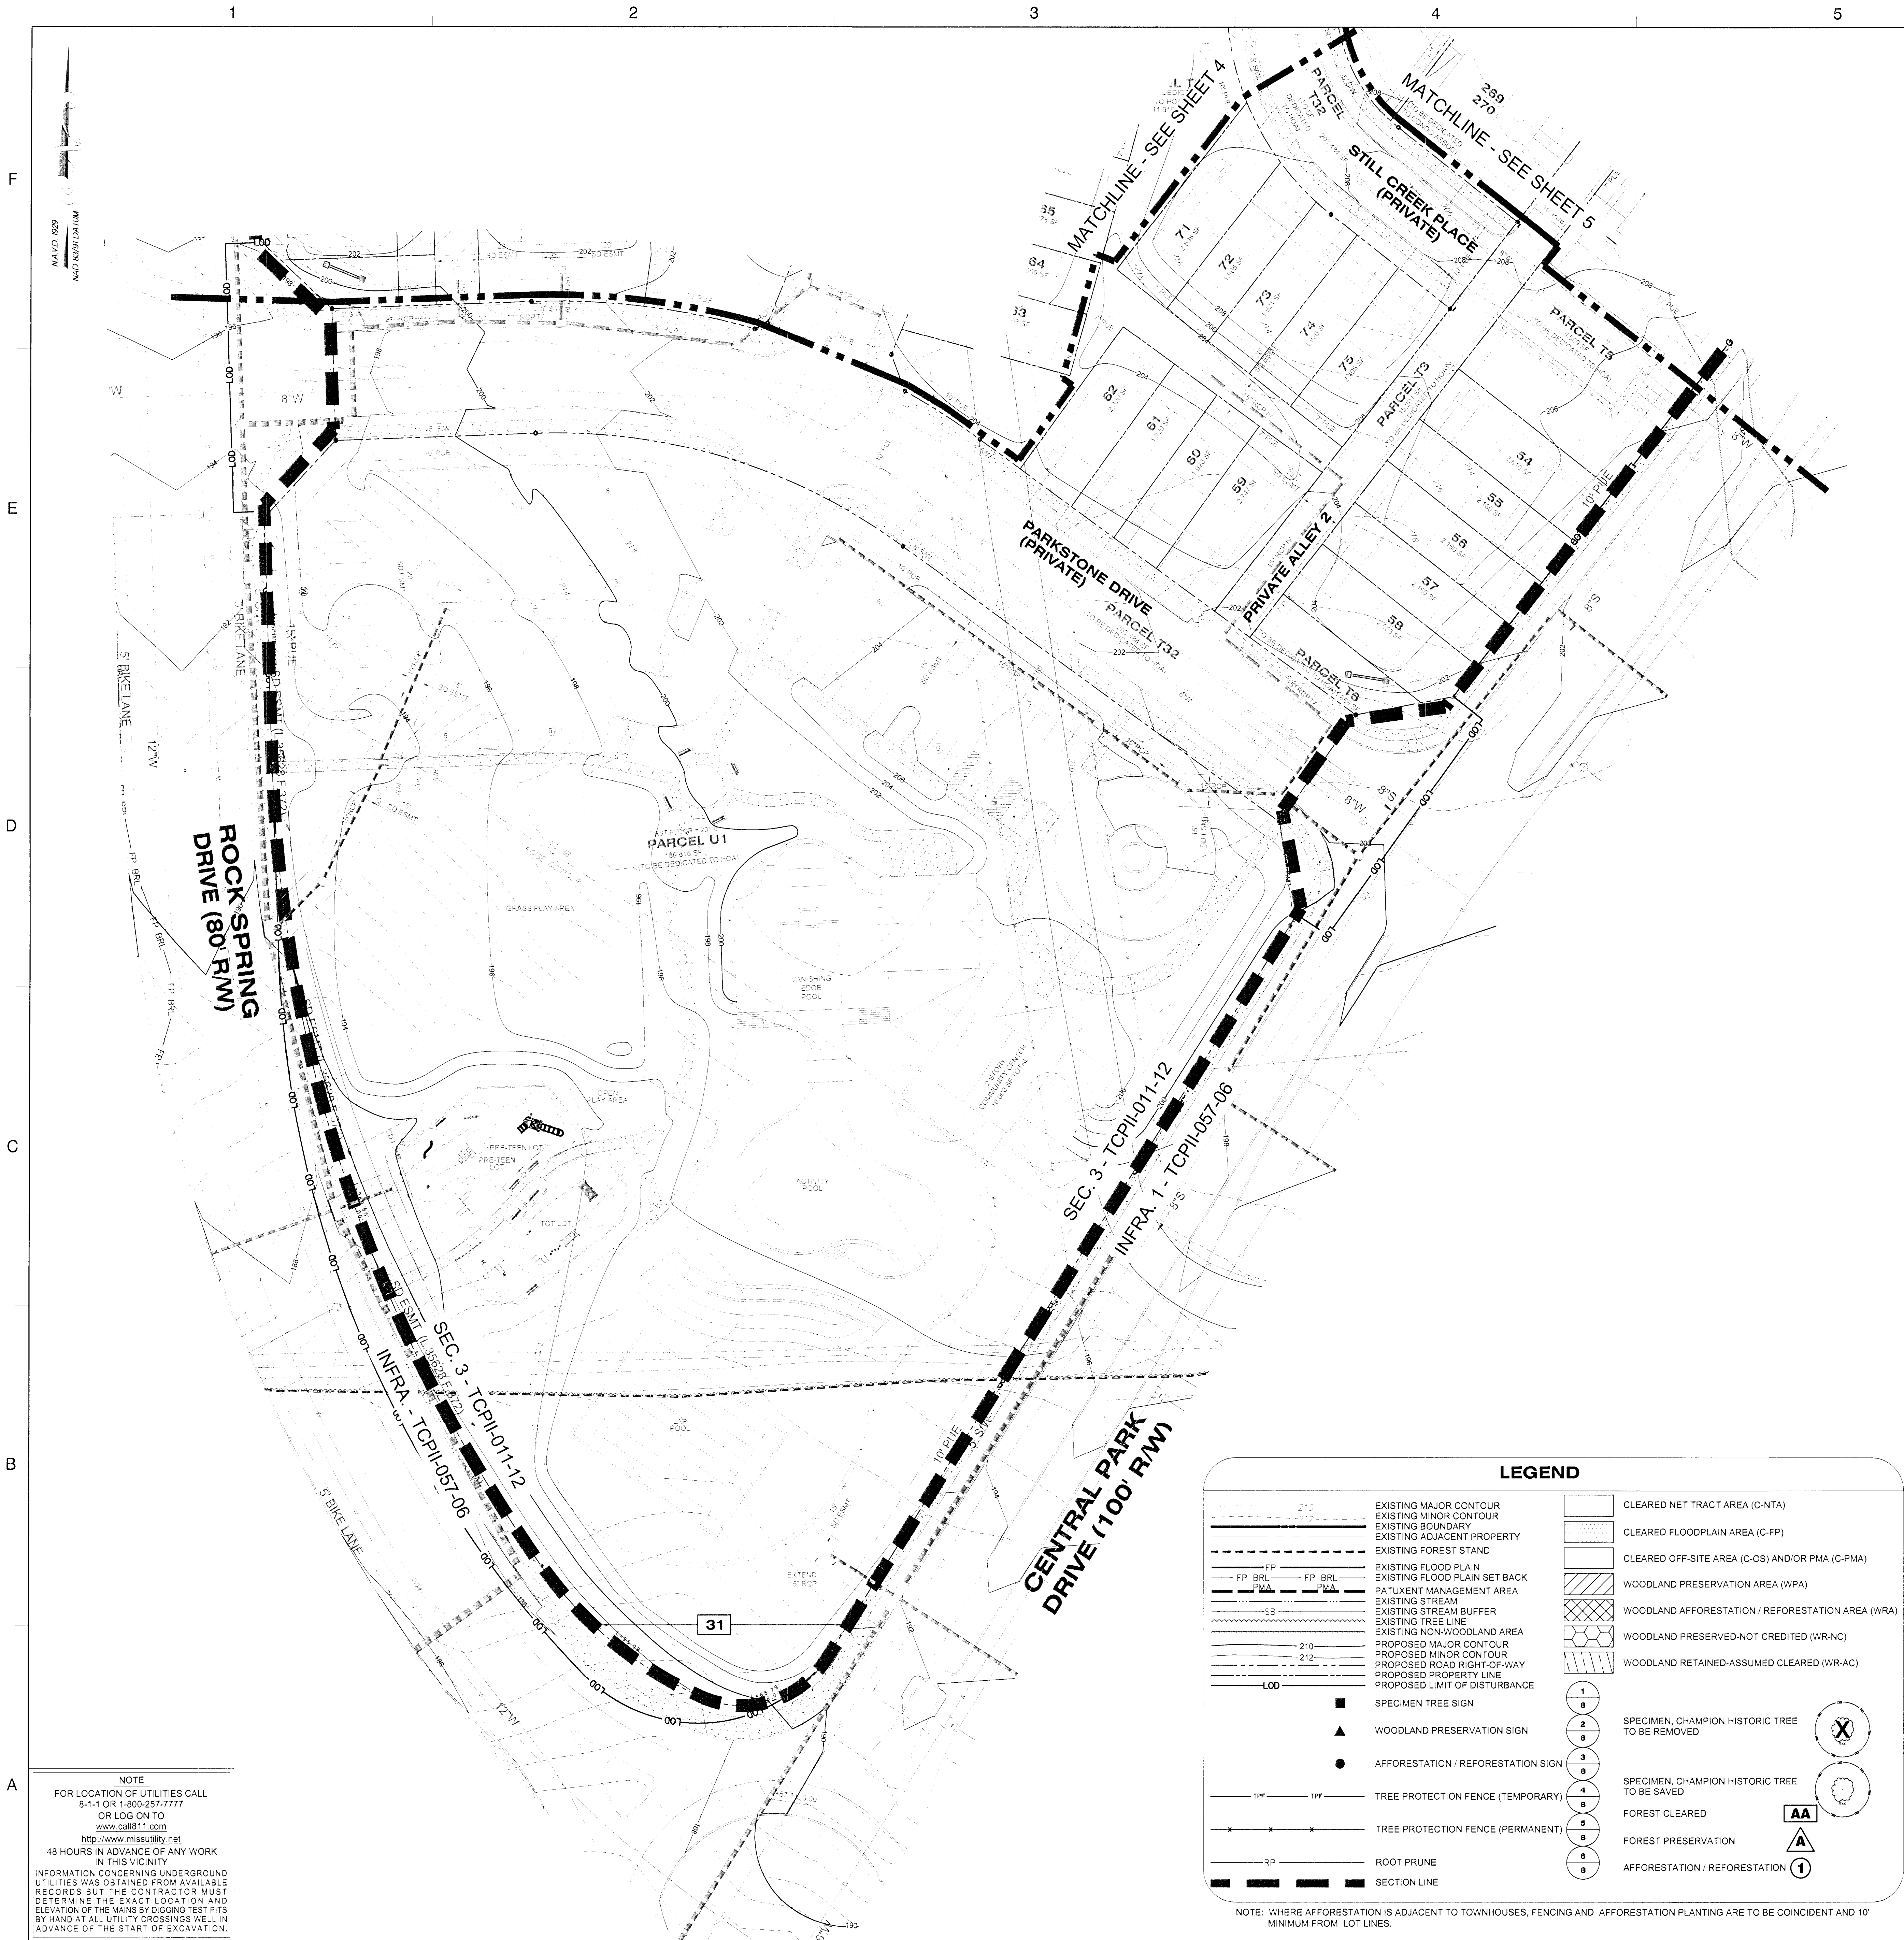

LEGEND	
	EXISTING MAJOR CONTOUR
	EXISTING MINOR CONTOUR
	EXISTING BOUNDARY
	EXISTING ADJACENT PROPERTY
	EXISTING FOREST STAND
	EXISTING FLOOD PLAIN
	EXISTING FLOOD PLAIN SET BACK
	PATUXENT MANAGEMENT AREA
	EXISTING STREAM
	EXISTING STREAM BUFFER
	EXISTING TREE LINE
	EXISTING NON-WOODLAND AREA
	PROPOSED MAJOR CONTOUR
	PROPOSED MINOR CONTOUR
	PROPOSED ROAD RIGHT-OF-WAY
	PROPOSED PROPERTY LINE
	PROPOSED LIMIT OF DISTURBANCE
	SPECIMEN TREE SIGN
	WOODLAND PRESERVATION SIGN
	AFFORESTATION / REFORESTATION SIGN
	TREE PROTECTION FENCE (TEMPORARY)
	TREE PROTECTION FENCE (PERMANENT)
	ROOT PRUNE
	SECTION LINE
	CLEARED NET TRACT AREA (C-NTA)
	CLEARED FLOODPLAIN AREA (C-FP)
	CLEARED OFF-SITE AREA (C-OS) AND/OR PMA (C-PMA)
	WOODLAND PRESERVATION AREA (WPA)
	WOODLAND AFFORESTATION / REFORESTATION AREA (WRA)
	WOODLAND PRESERVED-NOT CREDITED (WR-NC)
	WOODLAND RETAINED-ASSUMED CREDITED (WR-AC)
	SPECIMEN, CHAMPION HISTORIC TREE TO BE REMOVED
	SPECIMEN, CHAMPION HISTORIC TREE TO BE SAVED
	FOREST CLEARED
	FOREST PRESERVATION
	AFFORESTATION / REFORESTATION

NOTE: WHERE AFFORESTATION IS ADJACENT TO TOWNHOUSES, FENCING AND AFFORESTATION PLANTING ARE TO BE COINCIDENT AND 10' MINIMUM FROM LOT LINES.

SHEET 3	LABEL	AREA (ACRES)
WOODLAND CLEARED (C-NTA)	31	0.53
WOODLAND CLEARED FLOODPLAIN (C-FP)	-	-
WOODLAND CLEARED OFFSITE (C-OS) &/OR PMA	-	-
WOODLAND PRESERVATION (WPA)	-	-
WOODLAND RETAINED-NOT CREDITED (WR-NC)	-	-
WOODLAND RETAINED-ASSUMED CREDITED (WR-AC)	-	-
WOODLAND RE/AFFORESTATION (WRA)	-	-

M-NCPPC PRINCE GEORGE'S COUNTY PLANNING DEPARTMENT ENVIRONMENTAL PLANNING SECTION APPROVAL TREE CONSERVATION PLAN <b>TCPII-011-12</b>	
Approved by K. FINCH	Date 11/28/12
Approved by K. FINCH	Date 11/07/13
01 02 03 04 05	01 02 03 04 05

THIS BLOCK IS FOR OFFICIAL USE ONLY QA label certifies that this plan meets conditions of final approval by the Planning Board, its designee or the District Council. M-NCPPC APPROVAL	
PROJECT NAME: SMITH HOME FARM PROJECT NUMBER: SDP-1003-06	
For Conditions of Approval see the Plan Cover Sheet or Approval Sheet Revision numbers must be included in the Project Number	



Dewberry  
Consultants LLC  
Formerly known as  
Dewberry & Davis LLC


10003 DEREKWOOD LANE  
SUITE 504  
LANHAM, MD 20706  
301.731.9555  
301.731.9198 (FAX)  
www.dewberry.com

DEVELOPER/APPLICANT  
SHF PROJECT OWNER, LLC  
1999 AVENUE OF THE STARS, SUITE 2850  
LOS ANGELES, CA 90067

ATTORNEY/CONTACT:  
MARVA JO CAMP  
PH: 301-943-0255  
ADDITIONAL CONTACT:  
SEAN F. BRUCE  
S. F. BRUCE DEVELOPMENT  
PH: 301-562-0950

SMITH HOME FARM  
PRINCE GEORGE'S COUNTY  
MARYLAND  
6TH & 15TH ELECTION DISTRICTS  
TAX MAP: 90, 91 - GRID MULTIPLE  
ADJUSTED PARCEL: I PARCELS III, V, VI, VII, VIII & IX  
2007 MAP REFERENCE: 2005SE08-03, 2005SE08-09, 2005SE08-10

SEAL

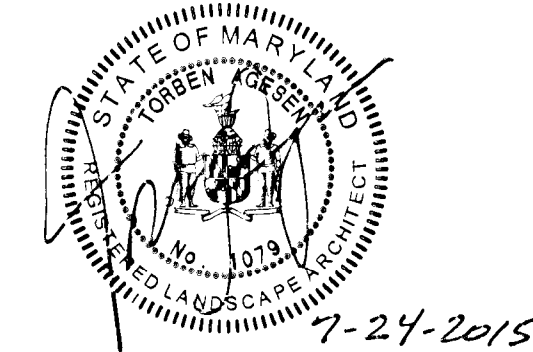

PROFESSIONAL CERTIFICATION:  
THIS PLAN WAS PREPARED OR  
APPROVED BY ME AND THAT I AM A  
FULLY REGISTERED LANDSCAPE ARCHITECT  
UNDER THE LAWS OF THE STATE OF  
MARYLAND, LICENSE NO. 10233,  
EXPIRATION DATE: JULY 14, 2016.

KEY PLAN



THIS TCPII PLAN SHEET CORRESPONDS  
TO SHEET 34 OF THE SDP AND  
LANDSCAPE PLANS

SCALE  
0' 30' 60'  
SCALE: 1"=30'

No.	DATE	BY	Description
1	11/28/12	K. FINCH	DESIGN
2	11/07/13	K. FINCH	REVISION

DRAWN BY: ERW  
APPROVED BY: TA  
CHECKED BY: LRB  
DATE: SEPTEMBER 2014

TITLE  
TYPE II TREE  
CONSERVATION  
PLAN  
SECTION 3

DEWBERRY JOB NO. 50038403

3

SHEET NO. 3 OF 10





M-NCPPC  
PRINCE GEORGE'S COUNTY  
PLANNING DEPARTMENT  
ENVIRONMENTAL PLANNING SECTION

TREE CONSERVATION PLAN

**TCPII-011-12**

	Approved by	Date
	K. FINCH	11/28/12
01	K. FINCH	11/07/13
02	<i>E. Finch</i>	<i>8/26/13</i>
03		
04		
05		

TITLE

TYPE II TREE  
CONSERVATION  
PLAN  
SECTION 3


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DEWBERRY JOB NO. 50038403

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4

SHEET NO. 4 OF 10



**Dewberry**  
Consultants LLC

Formerly known as  
Dewberry & Davis LLC



100503 DEREKWOOD LANE  
SUITE 204  
LANHAM MD 20706  
301 731 1500  
301 731 0188 (FAX)  
[www.dewberry.com](http://www.dewberry.com)

DEVELOPER/APPLICANT  
SHF PROJECT OWNER, LLC  
1999 AVENUE OF THE STARS, SUITE 2850  
LOS ANGELES, CA 90067

ATTORNEY CONTACT:  
MARVA JO CAMP  
PH: 301-943-0255

ADDITIONAL CONTACT:  
SEAN F. BRUCE  
S. F. BRUCE DEVELOPMENT  
PH: 301-502-9956

SMITH HOME FARM  
PRINCE GEORGE'S COUNTY  
MARYLAND  
16TH & 15TH ELECTION DISTRICTS  
TAX MAP: 90, 91 - GRID: MULTIPLE  
ADJUSTED PARCEL I, PARCELS III, IV, V, VII, & IX  
200' MAP REFERENCE: 205SE08-09, 206SE08-09, 207SE08

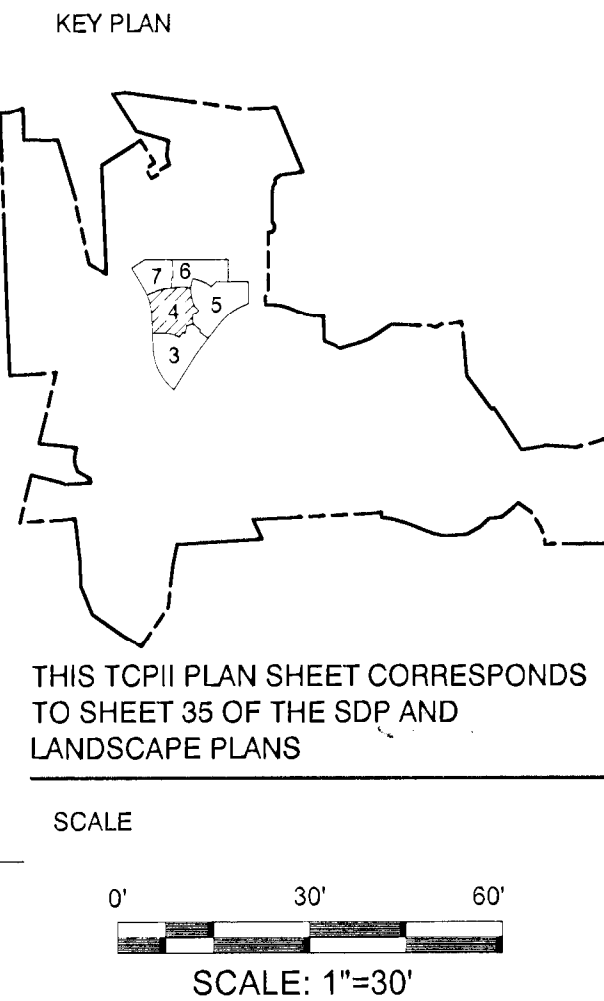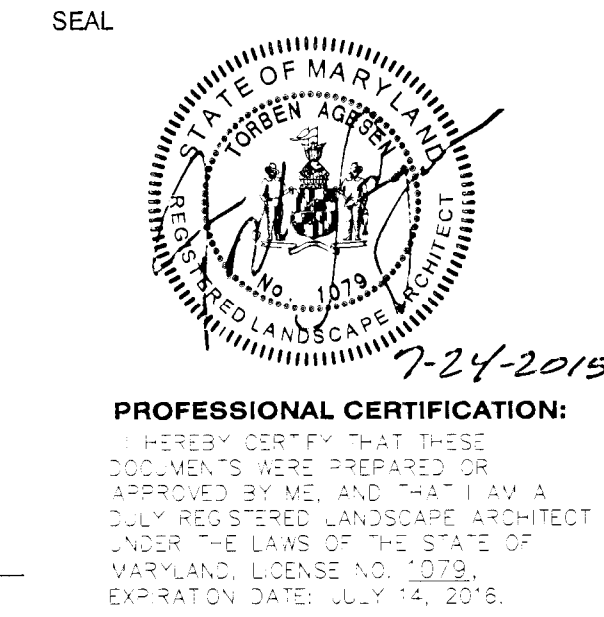

No.	DATE	BY	Description
REVISIONS			
			ERW
			TA
			LRB
			SEPTEMBER 2014



**LEGEND**

	EXISTING MAJOR CONTOUR
	EXISTING MINOR CONTOUR
	EXISTING BOUNDARY
	EXISTING ADJACENT PROPERTY
	EXISTING FOREST STAND
	EXISTING FLOOD PLAIN
	EXISTING FLOOD PLAIN SET BACK
	PATUXENT MANAGEMENT AREA
	EXISTING STREAM
	EXISTING STREAM BUFFER
	EXISTING TREE LINE
	EXISTING NON-WOODLAND AREA
	PROPOSED MAJOR CONTOUR
	PROPOSED MINOR CONTOUR
	PROPOSED ROAD RIGHT-OF-WAY
	PROPOSED PROPERTY LINE
	PROPOSED LIMIT OF DISTURBANCE
	SPECIMEN, CHAMPION HISTORIC TREE TO BE REMOVED
	SPECIMEN, CHAMPION HISTORIC TREE TO BE SAVED
	CLEARED NET TRACT AREA (C-NTA)
	CLEARED FLOODPLAIN AREA (C-FP)
	CLEARED OFF-SITE AREA (C-OS) AND/OR PMA (C-PMA)
	WOODLAND PRESERVATION AREA (WPA)
	WOODLAND AFFORESTATION / REFORESTATION AREA (WRA)
	WOODLAND PRESERVED-NOT CREDITED (WR-NC)
	WOODLAND RETAINED-ASSUMED CLEARED (WR-AC)
	FOREST CLEARED
	FOREST PRESERVATION
	AFFORESTATION / REFORESTATION
	SPECIMEN TREE SIGN
	WOODLAND PRESERVATION SIGN
	AFFORESTATION / REFORESTATION SIGN
	TREE PROTECTION FENCE (TEMPORARY)
	TREE PROTECTION FENCE (PERMANENT)
	ROOT PRUNE
	SECTION LINE

NOTE: WHERE AFFORESTATION IS ADJACENT TO TOWNHOUSES, FENCING AND AFFORESTATION PLANTING ARE TO BE COINCIDENT AND 10' MINIMUM FROM LOT LINES.

SHEET 5	LABEL	AREA (ACRES)
WOODLAND CLEARED (C-NTA)	-	-
WOODLAND CLEARED FLOODPLAIN (C-FP)	-	-
WOODLAND CLEARED OFFSITE (C-OS) &/OR PMA	-	-
WOODLAND PRESERVATION (WPA)	-	-
WOODLAND RETAINED-NOT CREDITED (WR-NC)	-	-
WOODLAND RETAINED-ASSUMED CLEARED (WR-AC)	-	-
WOODLAND RE/AFFORESTATION (WRA)	1	3.28

M-NCPPC  
PRINCE GEORGE'S COUNTY  
PLANNING DEPARTMENT  
ENVIRONMENTAL PLANNING SECTION  
APPROVAL  
TREE CONSERVATION PLAN  
**TCPII-011-12**  
Approved by \_\_\_\_\_ Date 11/28/12  
K. FINCH  
01 K. FINCH 11/07/13  
02 K. FINCH 02/21/15  
03  
04  
05



THIS BLOCK IS FOR OFFICIAL USE ONLY  
QR label certifies that this plan meets conditions of final approval by the Planning Board, its designee or the District Council.  
M-NCPPC  
APPROVAL  
PROJECT NAME: SMITH HOME FARM  
PROJECT NUMBER: SDP-1003/06  
For Conditions of Approval see Site Plan Cover Sheet or Approval Sheet  
Revision numbers must be included in the Project Number



NOTE  
FOR LOCATION OF UTILITIES CALL  
8-1-1 OR 1-800-257-7777  
OR LOG ON TO  
www.call811.com  
http://www.missutility.net  
48 HOURS IN ADVANCE OF ANY WORK  
IN THIS VICINITY  
INFORMATION CONCERNING UNDERGROUND UTILITIES WAS OBTAINED FROM AVAILABLE RECORDS, BUT THE CONTRACTOR MUST DETERMINE THE EXACT LOCATION AND ELEVATION OF THE MAINS BY DIGGING TEST PITS BY HAND AT ALL UTILITY CROSSINGS WELL IN ADVANCE OF THE START OF EXCAVATION.





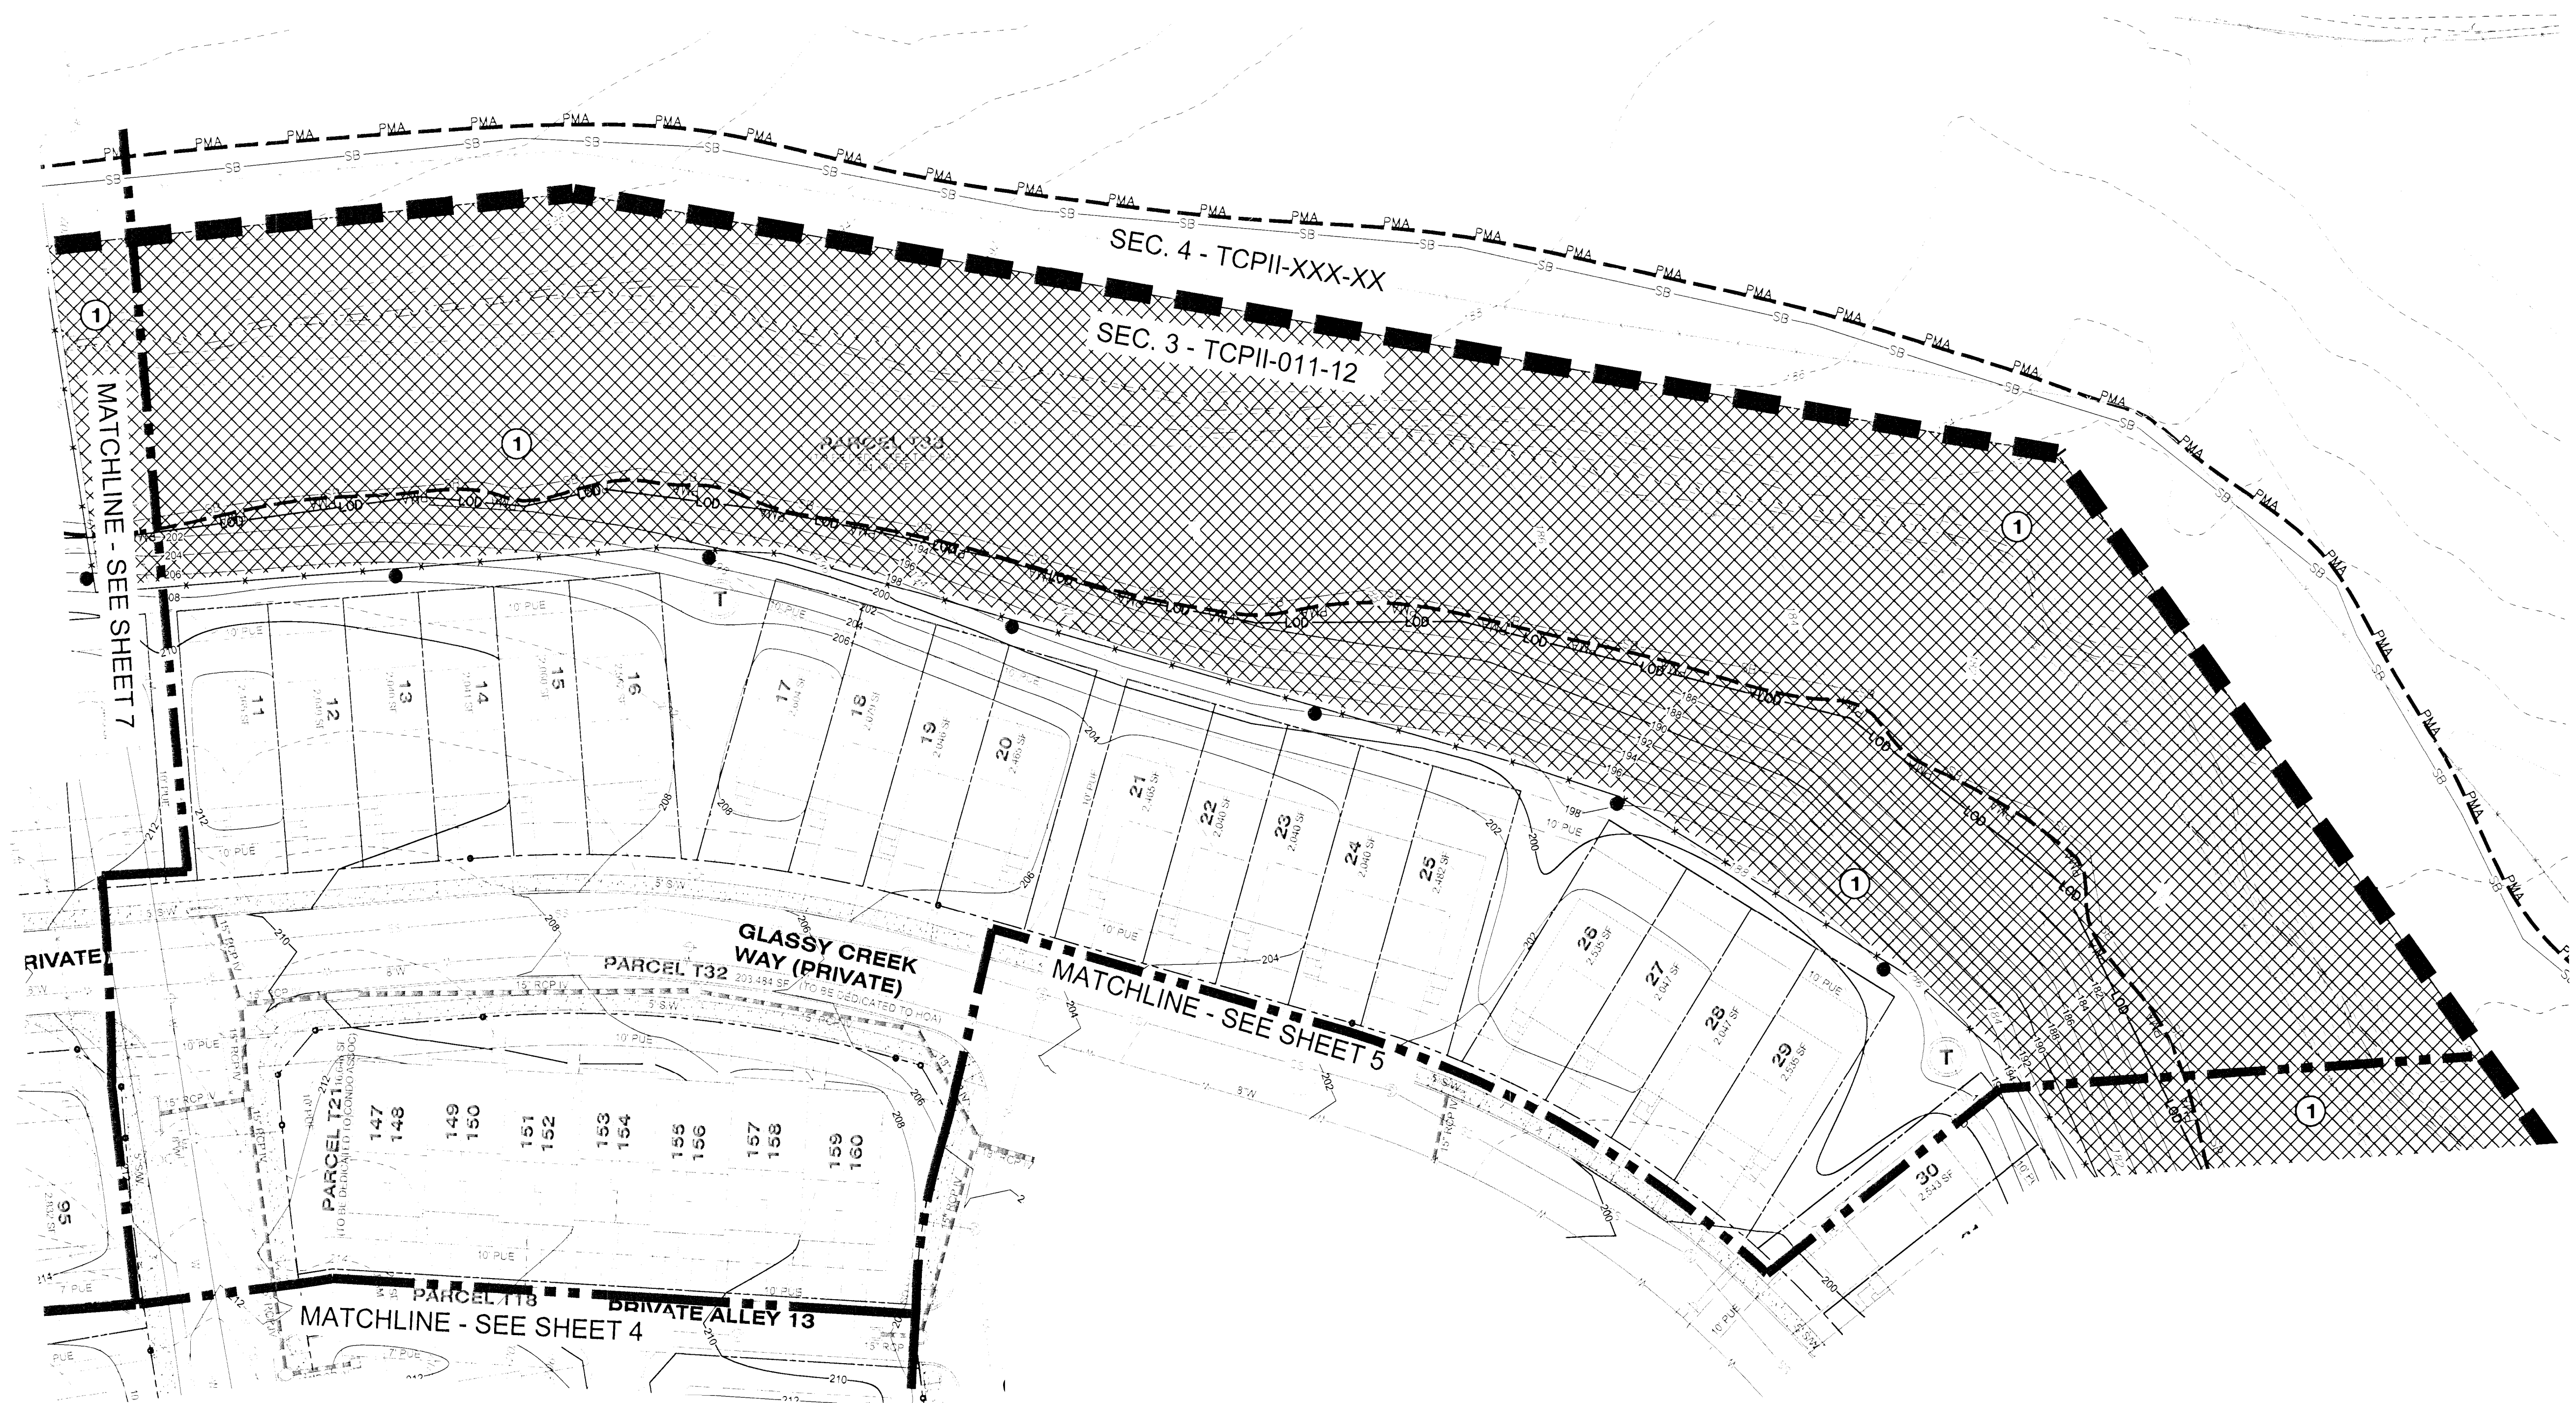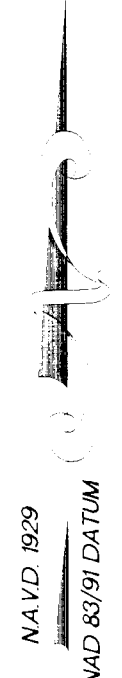

**LEGEND**

EXISTING MAJOR CONTOUR  
EXISTING MINOR CONTOUR  
EXISTING BOUNDARY  
EXISTING ADJACENT PROPERTY  
EXISTING FOREST STAND  
EXISTING FLOOD PLAIN  
EXISTING FLOOD PLAIN SET BACK  
PATIENT MANAGEMENT AREA  
EXISTING STREAM  
EXISTING STREAM BUFFER  
EXISTING TREE LINE  
EXISTING NON-WOODLAND AREA  
PROPOSED MAJOR CONTOUR  
PROPOSED MINOR CONTOUR  
PROPOSED ROAD RIGHT-OF-WAY  
PROPOSED PROPERTY LINE  
PROPOSED LIMIT OF DISTURBANCE  
SPECIMEN TREE SIGN  
WOODLAND PRESERVATION SIGN  
AFFORESTATION / REFORESTATION SIGN  
TREE PROTECTION FENCE (TEMPORARY)  
TREE PROTECTION FENCE (PERMANENT)  
ROOT PRUNE  
SECTION LINE

CLEARED NET TRACT AREA (C-NTA)  
CLEARED FLOODPLAIN AREA (C-FP)  
CLEARED OFF-SITE AREA (C-OS) AND/OR PMA (C-PMA)  
WOODLAND PRESERVATION AREA (WPA)  
WOODLAND AFFORESTATION / REFORESTATION AREA (WRA)  
WOODLAND PRESERVED-NOT CREDITED (WR-NC)  
WOODLAND RETAINED-ASSUMED CREDITED (WR-AC)  
SPECIMEN, CHAMPION HISTORIC TREE TO BE REMOVED  
SPECIMEN, CHAMPION HISTORIC TREE TO BE SAVED  
FOREST CLEARED  
FOREST PRESERVATION  
AFFORESTATION / REFORESTATION

NOTE: WHERE AFFORESTATION IS ADJACENT TO TOWNHOUSES, FENCING AND AFFORESTATION PLANTING ARE TO BE COINCIDENT AND 10' MINIMUM FROM LOT LINES.

NOTE:  
FOR LOCATION OF UTILITIES CALL  
8-1-1 OR 1-800-257-7777  
OR LOG ON TO  
www.call811.com  
http://www.missutility.net  
48 HOURS IN ADVANCE OF ANY WORK  
IN THIS VICINITY  
INFORMATION CONCERNING UNDERGROUND  
UTILITIES WAS OBTAINED FROM AVAILABLE  
RECORDS BUT THE CONTRACTOR MUST  
DETERMINE THE EXACT LOCATION AND  
ELEVATION OF THE MAINS BY DIGGING TEST PITS  
BY HAND AT ALL UTILITY CROSSINGS WELL IN  
ADVANCE OF THE START OF EXCAVATION.

SHEET 6	LABEL	AREA (ACRES)
WOODLAND CLEARED (C-NTA)	-	-
WOODLAND CLEARED FLOODPLAIN (C-FP)	-	-
WOODLAND CLEARED OFFSITE (C-OS) &/OR PMA	-	-
WOODLAND PRESERVATION (WPA)	-	-
WOODLAND RETAINED-NOT CREDITED (WR-NC)	-	-
WOODLAND RETAINED-ASSUMED CREDITED (WR-AC)	-	-
WOODLAND RE/AFFORESTATION (WRA)	1	3.28

M-NCPPC  
PRINCE GEORGE'S COUNTY  
PLANNING DEPARTMENT  
ENVIRONMENTAL PLANNING SECTION  
APPROVAL  
TREE CONSERVATION PLAN  
**TCP11-011-12**

Approved by: K. FINCH Date: 11/28/12  
Checked by: K. FINCH Date: 11/07/13

THIS BLOCK IS FOR OFFICIAL USE ONLY  
OK label certifies that this plan meets conditions of final approval by the Planning Board, its designee or the District Council.  
M-NCPPC  
APPROVAL  
PROJECT NAME: SMITH HOME FARM  
PROJECT NUMBER: SDP-1003/06  
For Conditions of Approval see Site Plan Cover Sheet or Approval Sheet  
Revision numbers must be included in the Project Number



**Dewberry**  
Consultants LLC  
Formerly known as  
Dewberry & Davis LLC

10003 DEREKWOOD LANE  
SUITE 204  
LAUREL, MD 20708  
301.731.5551  
301.731.0188 (FAX)  
www.dewberry.com

DEVELOPER/APPLICANT  
SHF PROJECT OWNER, LLC  
1999 AVENUE OF THE STARS, SUITE 2850  
LOS ANGELES, CA 90067

ATTORNEY CONTACT:  
MARVA JO CAMP  
PH: 301-943-0255

ADDITIONAL CONTACT:  
SEAN F. BRUCE  
S. F. BRUCE DEVELOPMENT  
PH: 301-502-0956

SMITH HOME FARM  
PRINCE GEORGE'S COUNTY  
MARYLAND  
6TH & 15TH ELECTION DISTRICTS  
TAX MAP: 90.91 - GRID: MULTIPLE  
ADJUSTED PARCEL 1 PARCELS II, IV, VI, VII, VIII & IX  
2007 MAP REFERENCE: 2065608-09, 2065609-09, 2075608

SEAL

PROFESSIONAL CERTIFICATION:  
I HEREBY CERTIFY THAT THESE  
CONCEPTS WERE PREPARED OR  
APPROVED BY ME, AND THAT I AM A  
LICENSED LANDSCAPE ARCHITECT  
UNDER THE LAWS OF THE STATE OF  
MARYLAND, LICENSE NO. 12345,  
EXPIRATION DATE: JULY 21, 2016

KEY PLAN

THIS TCP11 PLAN SHEET CORRESPONDS  
TO SHEET 37 OF THE SDP AND  
LANDSCAPE PLANS

SCALE

0' 30' 60'

SCALE: 1"=30'

REVISIONS

No.	DATE	BY	Description

DRAWN BY: ERW  
APPROVED BY: TA  
CHECKED BY: LRB  
DATE: SEPTEMBER 2014

TITLE  
**TYPE II TREE  
CONSERVATION  
PLAN  
SECTION 3**

DEWBERRY JOB NO. 50038403

**6**

SHEET NO. 6 OF 10





NOTE  
FOR LOCATION OF UTILITIES CALL  
8-1-1 OR 1-800-257-7777  
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48 HOURS IN ADVANCE OF ANY WORK  
IN THIS VICINITY  
INFORMATION CONCERNING UNDERGROUND  
UTILITIES WAS OBTAINED FROM AVAILABLE  
RECORDS BUT THE CONTRACTOR MUST  
DETERMINE THE EXACT LOCATION AND  
ELEVATION OF THE MAINS BY DIGGING TEST PITS  
BY HAND AT ALL UTILITY CROSSINGS WELL IN  
ADVANCE OF THE START OF EXCAVATION.



**LEGEND**

EXISTING MAJOR CONTOUR	EXISTING MINOR CONTOUR	EXISTING BOUNDARY	EXISTING ADJACENT PROPERTY	EXISTING FOREST STAND	EXISTING FLOOD PLAIN	EXISTING FLOOD PLAIN SET BACK	PATUXENT MANAGEMENT AREA	EXISTING STREAM	EXISTING STREAM BUFFER	EXISTING TREE LINE	EXISTING NON-WOODLAND AREA	PROPOSED MAJOR CONTOUR	PROPOSED MINOR CONTOUR	PROPOSED ROAD RIGHT-OF-WAY	PROPOSED PROPERTY LINE	PROPOSED LIMIT OF DISTURBANCE
SP-1	SP-2	SP-3	SP-4	SP-5	SP-6	SP-7	SP-8	SP-9	SP-10	SP-11	SP-12	SP-13	SP-14	SP-15	SP-16	SP-17
SP-18	SP-19	SP-20	SP-21	SP-22	SP-23	SP-24	SP-25	SP-26	SP-27	SP-28	SP-29	SP-30	SP-31	SP-32	SP-33	SP-34
SP-35	SP-36	SP-37	SP-38	SP-39	SP-40	SP-41	SP-42	SP-43	SP-44	SP-45	SP-46	SP-47	SP-48	SP-49	SP-50	SP-51
SP-52	SP-53	SP-54	SP-55	SP-56	SP-57	SP-58	SP-59	SP-60	SP-61	SP-62	SP-63	SP-64	SP-65	SP-66	SP-67	SP-68
SP-69	SP-70	SP-71	SP-72	SP-73	SP-74	SP-75	SP-76	SP-77	SP-78	SP-79	SP-80	SP-81	SP-82	SP-83	SP-84	SP-85
SP-86	SP-87	SP-88	SP-89	SP-90	SP-91	SP-92	SP-93	SP-94	SP-95	SP-96	SP-97	SP-98	SP-99	SP-100	SP-101	SP-102
SP-103	SP-104	SP-105	SP-106	SP-107	SP-108	SP-109	SP-110	SP-111	SP-112	SP-113	SP-114	SP-115	SP-116	SP-117	SP-118	SP-119
SP-120	SP-121	SP-122	SP-123	SP-124	SP-125	SP-126	SP-127	SP-128	SP-129	SP-130	SP-131	SP-132	SP-133	SP-134	SP-135	SP-136
SP-137	SP-138	SP-139	SP-140	SP-141	SP-142	SP-143	SP-144	SP-145	SP-146	SP-147	SP-148	SP-149	SP-150	SP-151	SP-152	SP-153
SP-154	SP-155	SP-156	SP-157	SP-158	SP-159	SP-160	SP-161	SP-162	SP-163	SP-164	SP-165	SP-166	SP-167	SP-168	SP-169	SP-170
SP-171	SP-172	SP-173	SP-174	SP-175	SP-176	SP-177	SP-178	SP-179	SP-180	SP-181	SP-182	SP-183	SP-184	SP-185	SP-186	SP-187
SP-188	SP-189	SP-190	SP-191	SP-192	SP-193	SP-194	SP-195	SP-196	SP-197	SP-198	SP-199	SP-200	SP-201	SP-202	SP-203	SP-204
SP-205	SP-206	SP-207	SP-208	SP-209	SP-210	SP-211	SP-212	SP-213	SP-214	SP-215	SP-216	SP-217	SP-218	SP-219	SP-220	SP-221
SP-222	SP-223	SP-224	SP-225	SP-226	SP-227	SP-228	SP-229	SP-230	SP-231	SP-232	SP-233	SP-234	SP-235	SP-236	SP-237	SP-238
SP-239	SP-240	SP-241	SP-242	SP-243	SP-244	SP-245	SP-246	SP-247	SP-248	SP-249	SP-250	SP-251	SP-252	SP-253	SP-254	SP-255
SP-256	SP-257	SP-258	SP-259	SP-260	SP-261	SP-262	SP-263	SP-264	SP-265	SP-266	SP-267	SP-268	SP-269	SP-270	SP-271	SP-272
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SP-290	SP-291	SP-292	SP-293	SP-294	SP-295	SP-296	SP-297	SP-298	SP-299	SP-300	SP-301	SP-302	SP-303	SP-304	SP-305	SP-306
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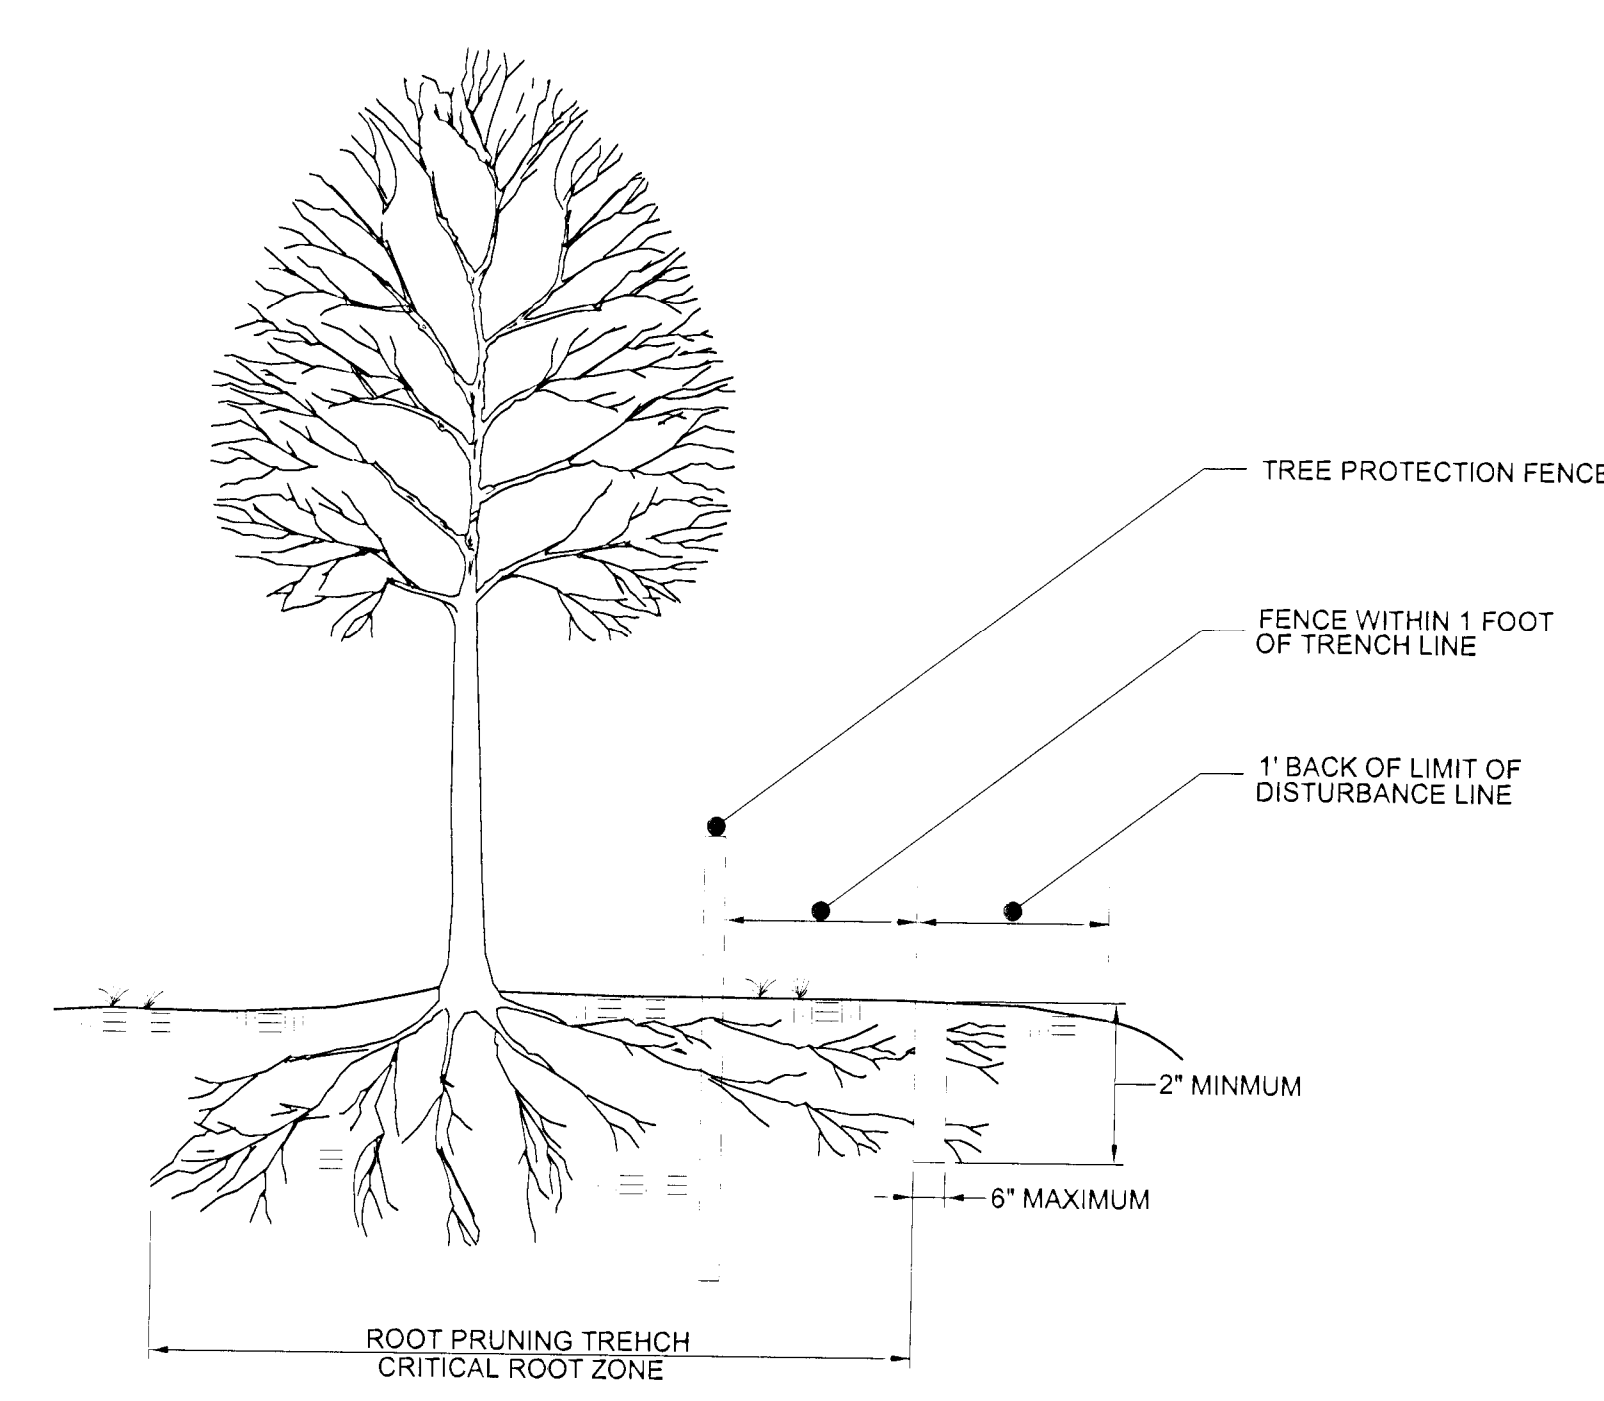
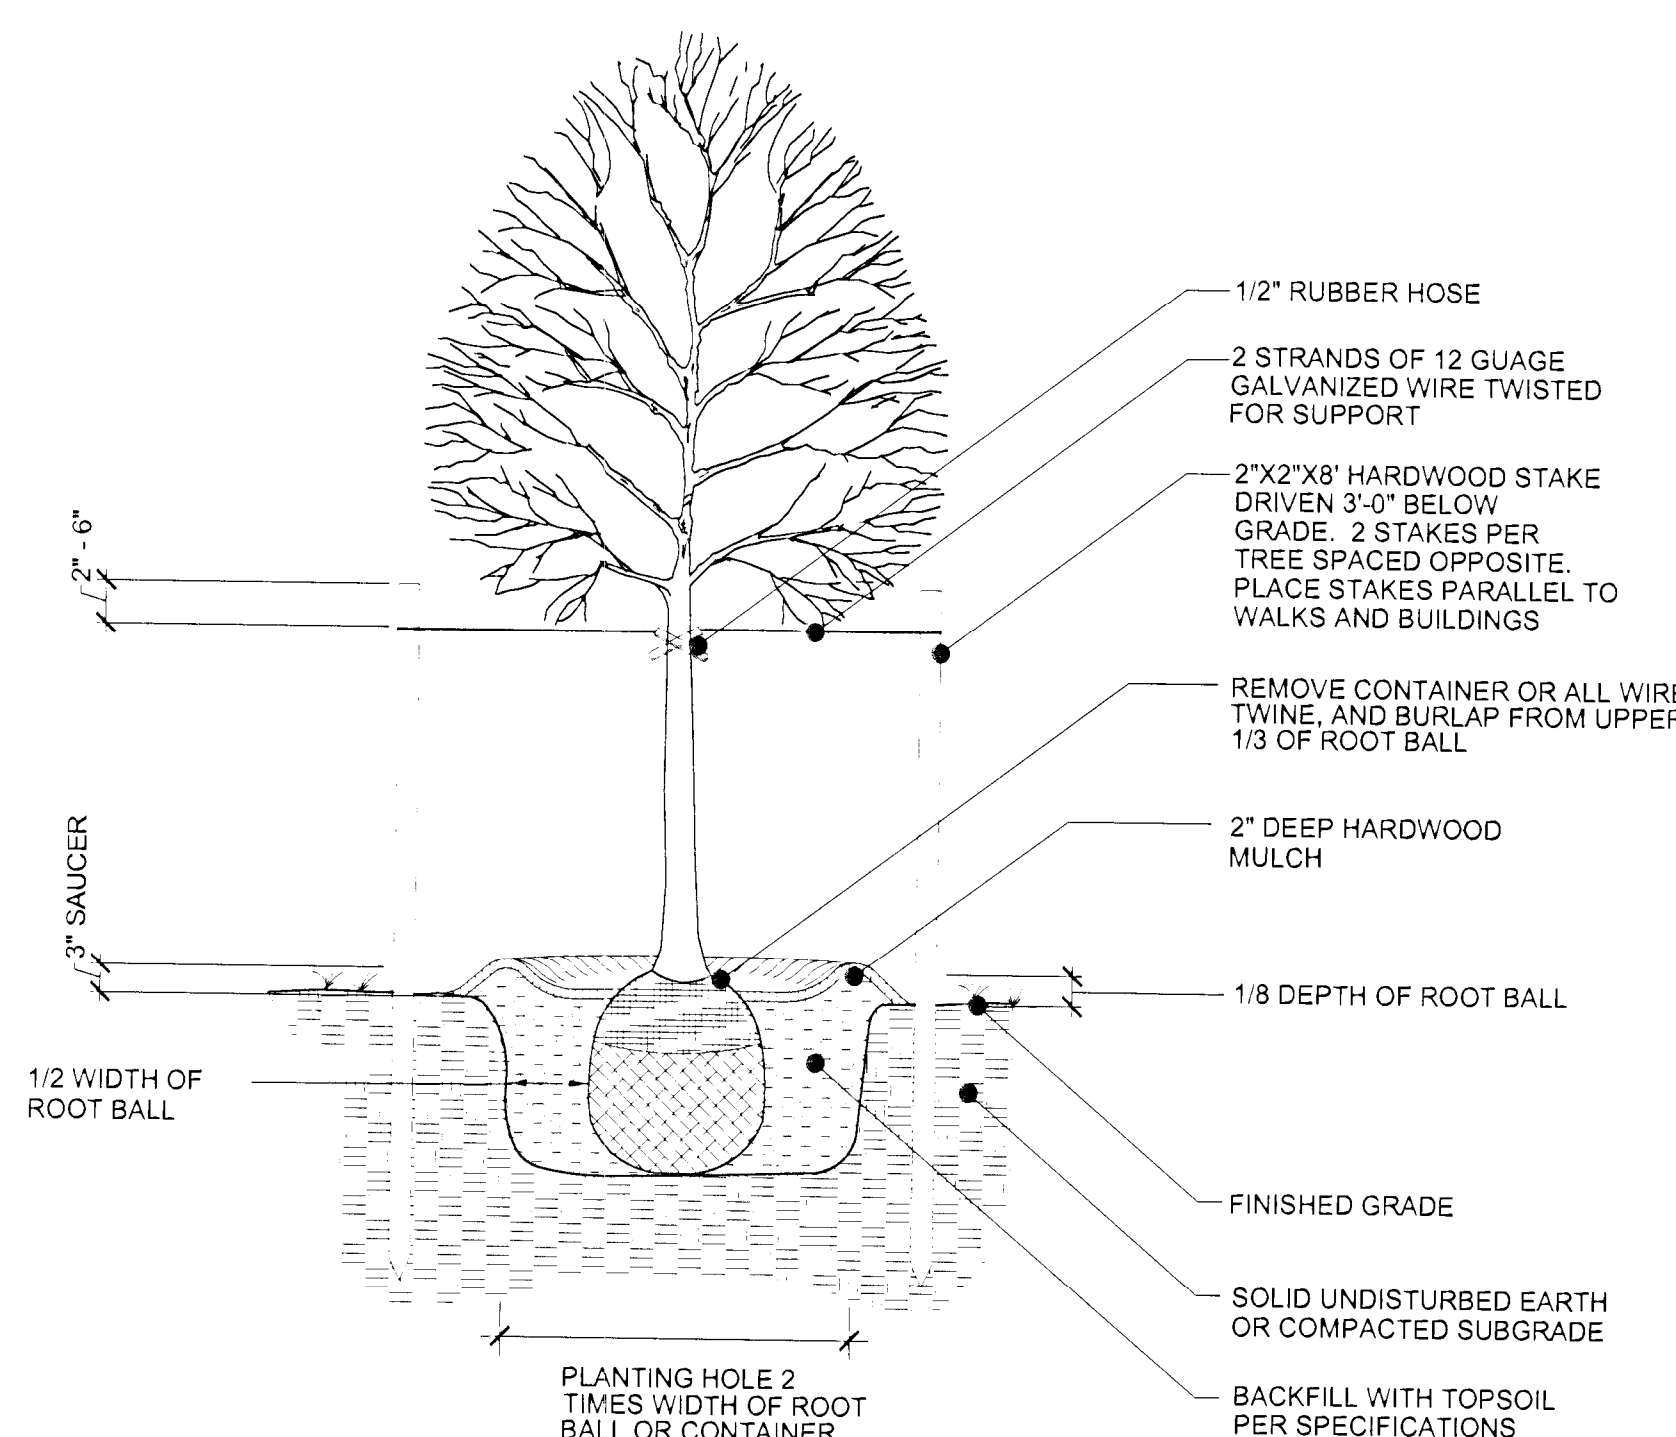
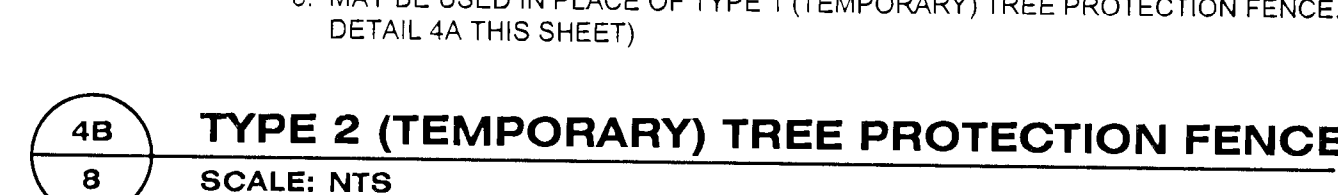


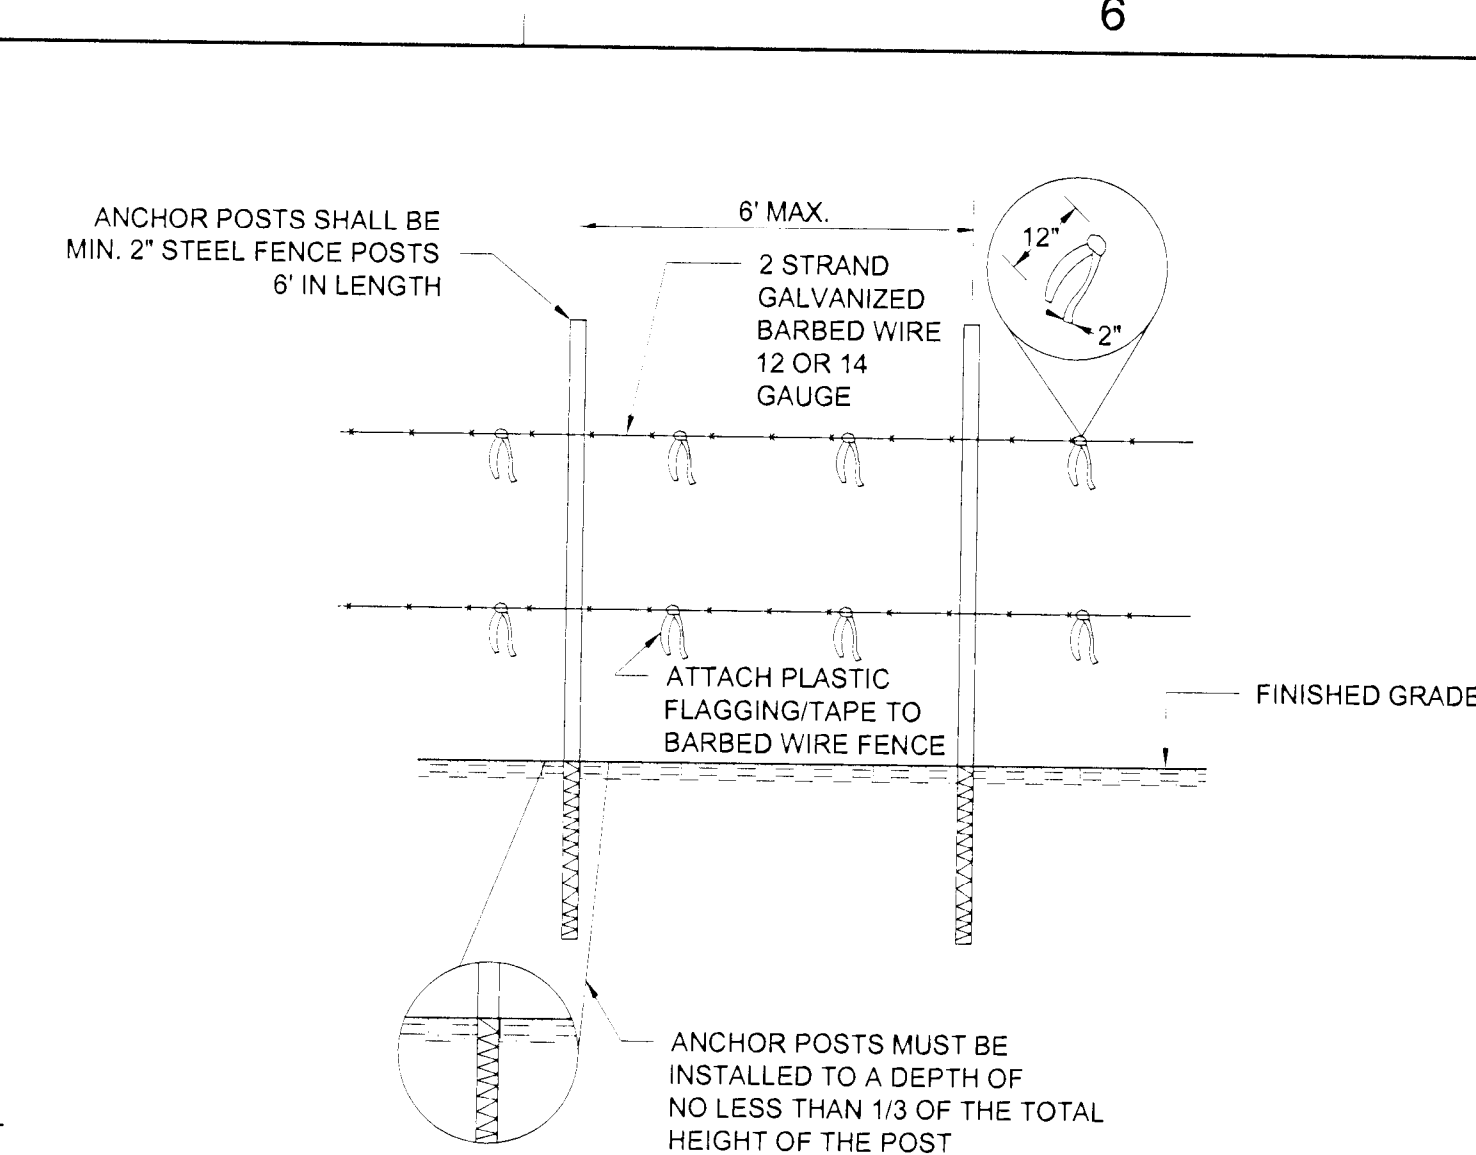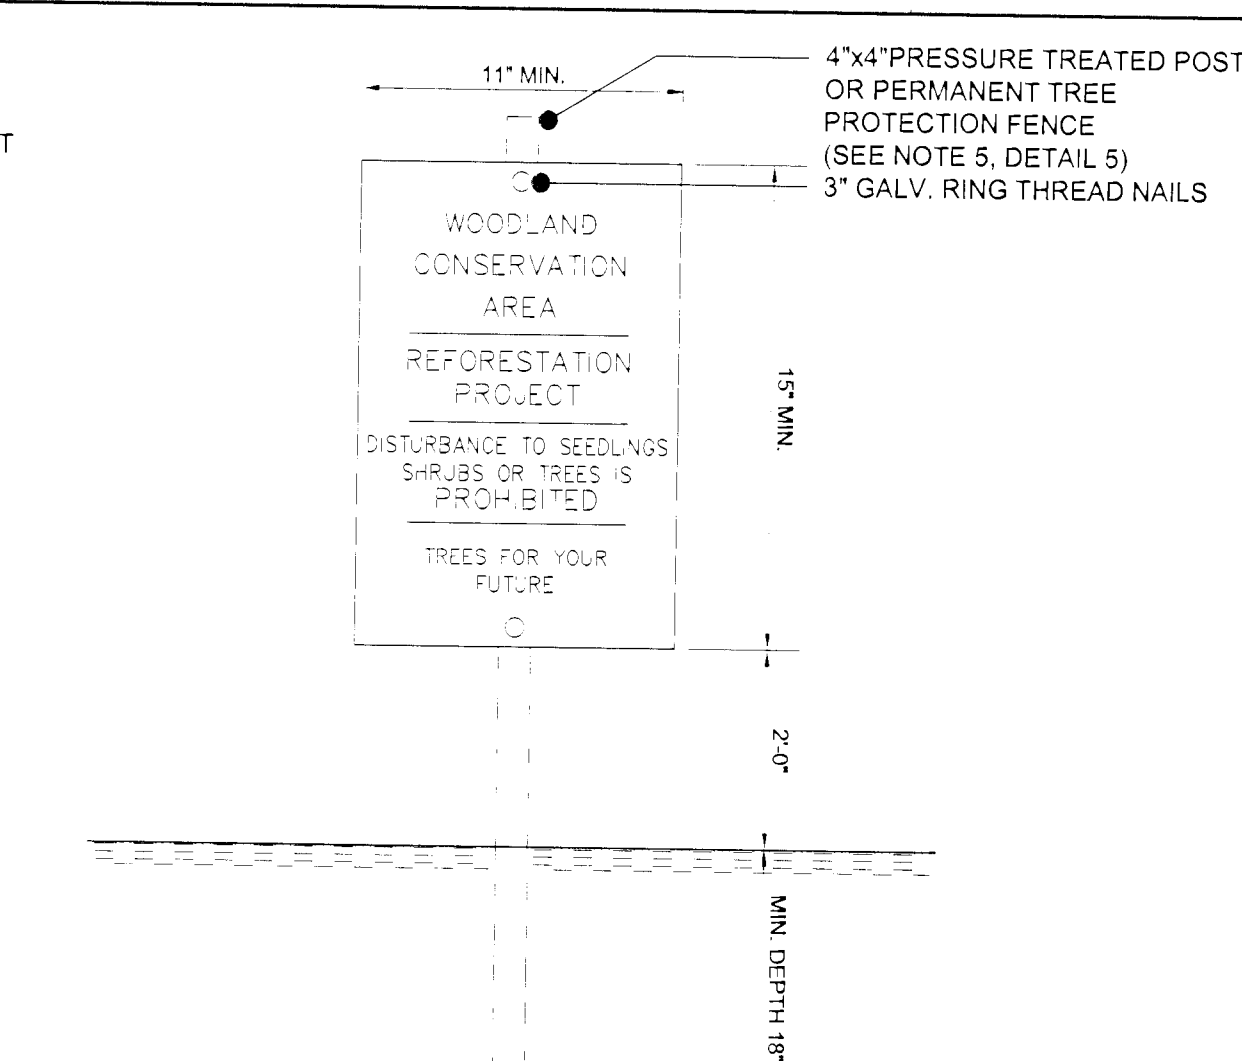

- NOTES:
1. ATTACHMENT OF SIGNS TO TREES IS PROHIBITED.
  2. SIGNS SHOULD BE PROPERLY MAINTAINED.
  3. AVOID INJURY TO ROOTS WHEN PLACING POSTS FOR THE SIGNS.
  4. SIGNS SHOULD BE POSTED TO BE VISIBLE TO ALL CONSTRUCTION PERSONNEL FROM ALL DIRECTIONS.
  5. SIGNS SHOULD BE INSTALLED AT SAME TIME AS TREE PROTECTION DEVICE.
  6. LOCATE SIGNS APPROXIMATELY EVERY 50' ALONG FENCING.
  7. SIGNS SHOULD BE IN PLACE IMMEDIATELY FOLLOWING STAKE OUT OF L.O.D. AND REMAIN IN PLACE IN PERPETUITY.

- NOTES:
1. FOREST PROTECTION DEVICE ONLY.
  2. RETENTION AREA WILL BE SET AS PART OF THE REVIEW PROCESS.
  3. BOUNDARIES OF RETENTION AREA SHOULD BE STAKED AND FLAGGED PRIOR TO INSTALLING DEVICES
  4. AVOID ROOT DAMAGE WHEN PLACING ANCHOR POSTS.
  5. DEVICE SHOULD BE PROPERLY MAINTAINED DURING CONSTRUCTION.
  6. PROTECTIVE SIGNAGE IS ALSO REQUIRED.
  7. MAY BE USED IN PLACE OF TYPE 2 (TEMPORARY) TREE PROTECTION FENCE. (SEE DETAIL 4B THIS SHEET)

- NOTES:
1. FOREST PROTECTION DEVICE ONLY.
2. RETENTION AREA WILL BE SET AS PART OF THE REVIEW PROCESS.
3. BOUNDARIES OF RETENTION AREA SHOULD BE STAKED AND FLAGGED PRIOR TO INSTALLING DEVICES.
4. AVOID ROOT DAMAGE WHEN PLACING ANCHOR POSTS.
5. BARBED WIRE SHOULD BE SECURELY ATTACHED TO POST.
6. DEVICE SHOULD BE PROPERLY MAINTAINED DURING CONSTRUCTION.
7. PROTECTIVE SIGNAGE IS ALSO REQUIRED.
8. MAY BE USED IN PLACE OF TYPE 1 (TEMPORARY) TREE PROTECTION FENCE. (SEE DETAIL 4A THIS SHEET)



- NOTES:
1. DETAIL APPLIES TO B&B OR CONTAINER PLANTING.
  2. WHEN PLANTING ON A SLOPE, ENSURE LANDSCAPING IS INSTALLED VERTICAL AND PLUMB.
  3. MULCH SAUCER HEIGHT SHALL BE LEVEL AND UNIFORM AROUND CIRCUMFERENCE OF PLANT BASE

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1. DETAIL APPLIES TO B & B OR CONTAINER PLANTING.  
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3. MULCH SAUCER HEIGHT SHALL BE LEVEL AND UNIFORM AROUND CIRCUMFERENCE OF PLANT BASE


- NOTES:
1. RETENTION AREAS TO BE ESTABLISHED AS PART OF THE FOREST CONSERVATION PLAN REVIEW PROCESS
  2. BOUNDARIES OF RETENTION AREAS SHOULD BE STAKED, FLAGGED AND/OR FENCED PRIOR TO TRENCHING
  3. EXACT LOCATION OF TRENCH SHOULD BE IDENTIFIED
  4. TRENCH SHOULD BE IMMEDIATELY BACKFILLED WITH SOIL REMOVED OR OTHER HIGH ORGANIC SOIL.
  5. ROOTS SHOULD BE CLEANLY CUT USING VIBRATORY KNIFE OR OTHER ACCEPTABLE EQUIPMENT.



LOCATE LARGER TREES (B&B OR CONTAINER) OR TRANSPLANT STOCK AT THE PERIMETER OF REFORESTATION (AFFORESTATION) PLANTINGS. PLANT WHIPS OR SEEDLING GROWN STOCK IN THE INTERIOR.

PROTECTIVE FENCING

★ | WHIPS OR SEEDLINGS

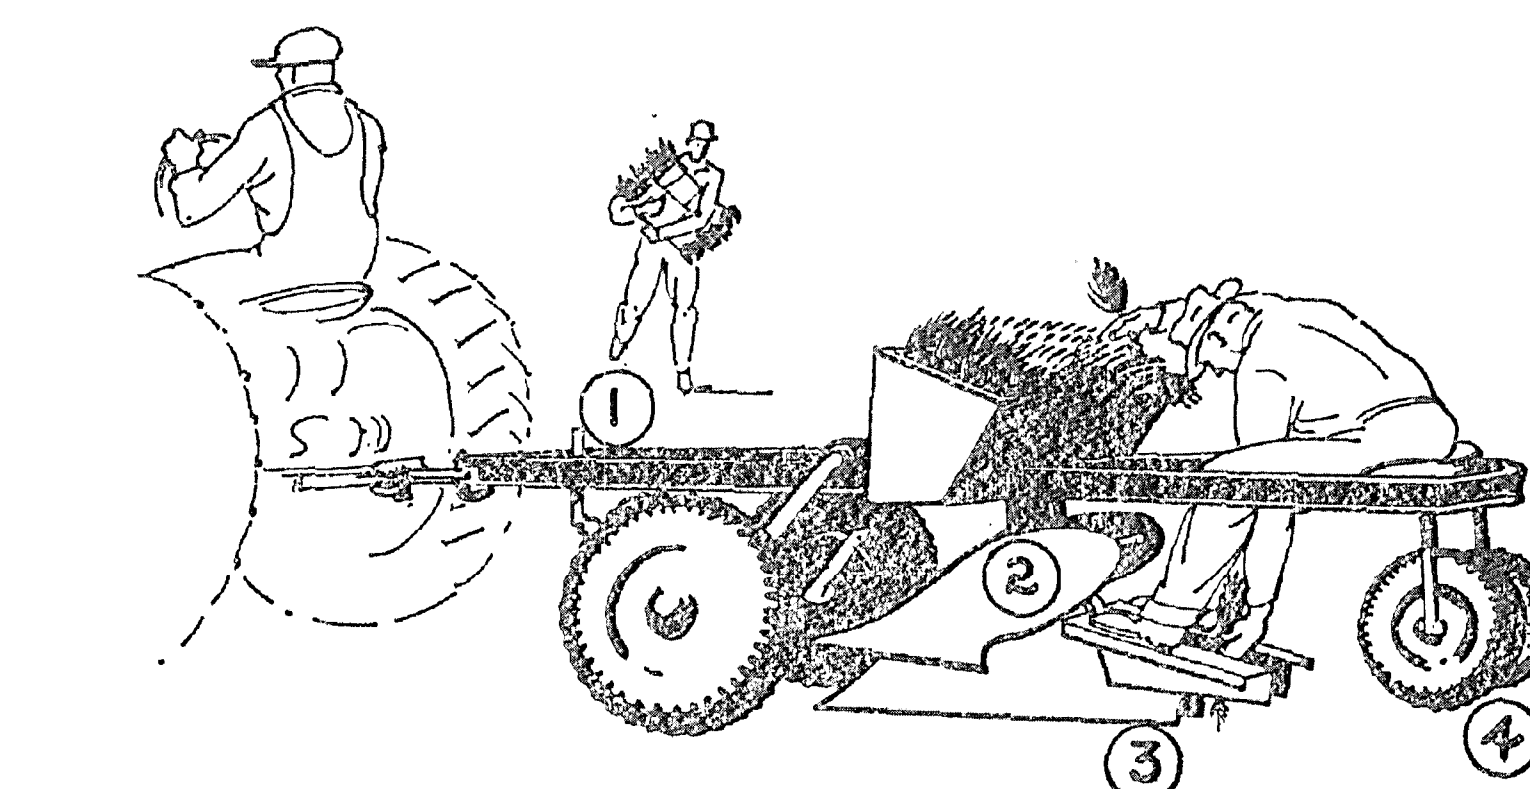


(1) Rolling coulters. (2) Double mouldboard plow or middle buster. Not essential in the absence of heavy ground cover. (3) Planting shoe, which opens the trench. (4) Packing wheels, which close trench and firm the soil.

- NOTES:
1. SOURCE: ADAPTED FROM FOREST CONSERVATION MANUAL, 1991.
  2. MULCHING NEWLY PLANTED SEEDLINGS HELPS THE SOIL RETAIN MOISTURE AND PROTECTS THE SEEDLING FROM COMPACTION AND STEM INJURIES.


- NOTES:
1. SOURCE: UNKNOWN
  2. MULCHING NEWLY PLANTED SEEDLINGS HELPS THE SOIL RETAIN MOISTURE AND PROTECTS THE SEEDLING FROM COMPACTION AND STEM INJURIES.



<p>M-NCPPC PRINCE GEORGE'S COUNTY PLANNING DEPARTMENT ENVIRONMENTAL PLANNING SECTION APPROVAL TREE CONSERVATION PLAN</p> <p><b>TCPII-011-12</b></p> <p>Approved by _____ Date _____</p> <p>K. FINCH 11/28/12</p> <p>01 _____ 11/07/13</p> <p>02 <i>ELP/ku</i></p> <p>03 <i>2/2/15</i></p> <p>04 _____</p> <p>05 _____</p>		<p>THIS BLOCK IS FOR OFFICIAL USE ONLY</p> <p>QR label verifies that this plan meets conditions of final approval by the Planning Board, its designee or the District Council.</p> <p><b>M-NCPPC APPROVAL</b></p>  <p>PROJECT NAME: SMITH HOME FARM</p> <p>PROJECT NUMBER: SDP-1003-06</p> <p>For Conditions of Approval, see Site Plan Cover Sheet or Approval Sheet. Revision numbers must be included in the Project Number.</p>
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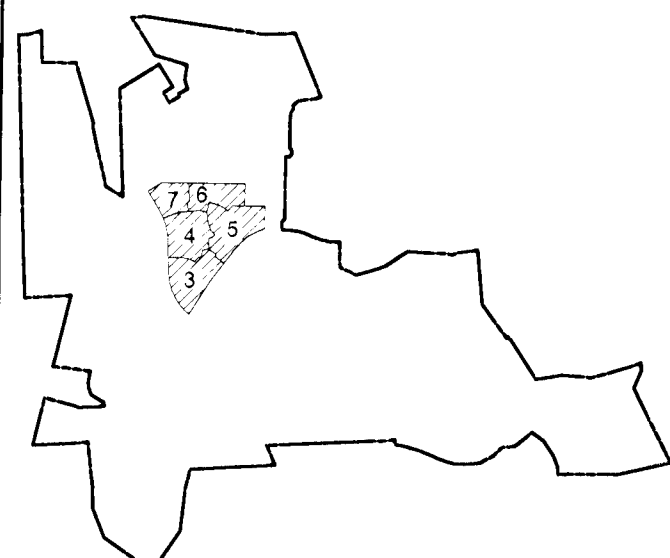
**SMITH HOME FARM  
PRINCE GEORGE'S COUNTY  
MARYLAND  
6TH & 15TH ELECTION DISTRICTS**

TAX MAP: 90-91 - GRID: MULTIPLE  
ADJUSTED PARCEL I, PARCELS III, IV, V, VI, VII, VIII & IX  
2007 MAP REFERENCE: 20S0E08-09, 20S0E08-09, 20T5E08

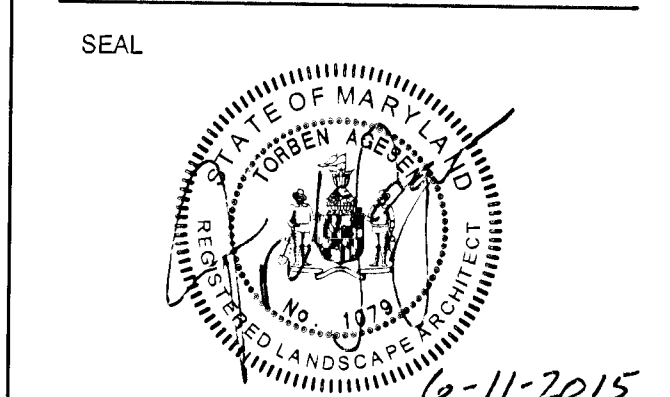

**PROFESSIONAL CERTIFICATION:**  
I HEREBY CERTIFY THAT THESE  
DOCUMENTS WERE PREPARED OR  
APPROVED BY ME, AND THAT I AM A  
DULY REGISTERED LANDSCAPE ARCHITECT  
UNDER THE LAWS OF THE STATE OF  
MARYLAND, LICENSE NO. 1979,  
EXPIRATION DATE: JULY 14, 2016.

## KEY PLAN



SCALE

**AS-SHOWN**

[illegible]

DRAWN BY	ERW
APPROVED BY	TA
CHECKED BY	LRB
DATE	SEPTEMBER 2014

TITI

TYPE II TREE  
CONSERVATION  
PLAN  
SECTION 3

DETAILS, NOTES & COMPUTATIONS

DEWBERRY JOB NO. 50038403

8



SPECIMEN, CHAMPION, AND HISTORIC TREES SUMMARY

Note: Trees were tagged with a metal tag corresponding to the number below. Tags were placed approximately 5' from the ground with colored flagging attached. Tree locations are approximate.

Tag #	Common Name	Scientific Name	DBH (Inches)	Remarks/Condition	Proposed Disposition	Plan Section
1	Tulip Tree	<i>Liriodendron tulipifera</i>	34	Good	Save	offsite
2	Southern Red Oak	<i>Quercus falcata</i>	34	Poor, trunk damage	Save	offsite
3	Southern Red Oak	<i>Quercus falcata</i>	39	Fair, twin	Save	2
4	White Oak	<i>Quercus alba</i>	43	Fair	Save	offsite
5	White Oak	<i>Quercus alba</i>	40	Good	Save	2
6	Tulip Tree	<i>Liriodendron tulipifera</i>	30	Fair	Save	2
7	Tulip Tree	<i>Liriodendron tulipifera</i>	30	Fair	Save	2
8	White Oak	<i>Quercus alba</i>	50	Good	Save	offsite
9	Tulip Tree	<i>Liriodendron tulipifera</i>	32	Fair	Save	2
10	Tulip Tree	<i>Liriodendron tulipifera</i>	30	Fair	Save	2
11	Tulip Tree	<i>Liriodendron tulipifera</i>	31	Fair, twin	Save	offsite
12	Tulip Tree	<i>Liriodendron tulipifera</i>	30	Good	Save	offsite
13	Southern Red Oak	<i>Quercus falcata</i>	30	Good	Save	offsite
14	Red Maple	<i>Acer rubrum</i>	45	Fair, 3 stem	Save	2
15	Tulip Tree	<i>Liriodendron tulipifera</i>	34	Good	Remove	2
16	Tulip Tree	<i>Liriodendron tulipifera</i>	33	Good	Remove	2
17	Tulip Tree	<i>Liriodendron tulipifera</i>	30	Fair, twin with #18	Remove	2
18	Tulip Tree	<i>Liriodendron tulipifera</i>	32	Fair, twin with 30"	Remove	2
19	Pin Oak	<i>Quercus palustris</i>	36	Poor, insect damage	Remove	2
20	Red Maple	<i>Acer rubrum</i>	34	Good	Remove	2
21	Tulip Tree	<i>Liriodendron tulipifera</i>	53	Fair, twin	Save	offsite
22	Tulip Tree	<i>Liriodendron tulipifera</i>	34	Fair	Save	offsite
23	Tulip Tree	<i>Liriodendron tulipifera</i>	31	Good	Remove	2
24	Tulip Tree	<i>Liriodendron tulipifera</i>	33	Fair	Remove	2
25	White Oak	<i>Quercus alba</i>	39	Poor, half missing	Remove	2
26	White Oak	<i>Quercus alba</i>	32	Fair	Save	2
27	White Oak	<i>Quercus alba</i>	30	Good	Remove	2
28	American Beech	<i>Fagus grandifolia</i>	39	Poor	Save	2
29	Tulip Tree	<i>Liriodendron tulipifera</i>	30	Fair	Remove	2
30	Tulip Tree	<i>Liriodendron tulipifera</i>	39	Fair	Remove	2
31	Tulip Tree	<i>Liriodendron tulipifera</i>	31	Good	Remove	2
32	Green Ash	<i>Fraxinus pennsylvanica</i>	49	Fair	Save	park
33	Red Maple	<i>Acer rubrum</i>	40	Fair, stream bank	Save	park
34	Tulip Tree	<i>Liriodendron tulipifera</i>	39	Good	Save	park
35	American Beech	<i>Fagus grandifolia</i>	30	Good	Save	park
36	Tulip Tree	<i>Liriodendron tulipifera</i>	52	Fair	Save	park
37	Sweetgum	<i>Liquidambar styraciflua</i>	31	Good	Save	park
38	Red Maple	<i>Acer rubrum</i>	46	Fair	Save	park
39	Sycamore	<i>Platanus occidentalis</i>	37	Fair, stream bank	Save	park
40	Sycamore	<i>Platanus occidentalis</i>	50	Fair	Save	infra 2
41	Tulip Tree	<i>Liriodendron tulipifera</i>	37	Fair	Save	park
42	Tulip Tree	<i>Liriodendron tulipifera</i>	49	Good	Save	park
43	Tulip Tree	<i>Liriodendron tulipifera</i>	46	Good	Save	park
44	Pin Oak	<i>Quercus palustris</i>	45	Fair, insect damage	Save	4
45	Pin Oak	<i>Quercus palustris</i>	38	Good	Save	4
46	Tulip Tree	<i>Liriodendron tulipifera</i>	46	Good	Save	4
47	Pin Oak	<i>Quercus palustris</i>	47	Good	Save	4
48	Pin Oak	<i>Quercus palustris</i>	42	Good	Save	retained
49	Tulip Tree	<i>Liriodendron tulipifera</i>	43	Good	Save	retained
50	Red Maple	<i>Acer rubrum</i>	50	Poor, 1/2 missing	Save	retained
51	Sweetgum	<i>Liquidambar styraciflua</i>	34	Good	Save	retained
52	River Birch	<i>Betula nigra</i>	33	Fair	Save	retained
53	Tulip Tree	<i>Liriodendron tulipifera</i>	37	Fair	Save	offsite
54	Tulip Tree	<i>Liriodendron tulipifera</i>	46	Fair	Save	retained
55	Tulip Tree	<i>Liriodendron tulipifera</i>	35	Very poor, damaged	Save	retained
56	Sycamore	<i>Platanus occidentalis</i>	33	Fair, twin	Save	park
57	Tulip Tree	<i>Liriodendron tulipifera</i>	30	Poor	Save	park
58	Pin Oak	<i>Quercus palustris</i>	31	Good	Save	park
59	Red Oak	<i>Quercus rubra</i>	39	Fair	Save	park
60	Silver Maple	<i>Acer saccharinum</i>	31	Fair	Save	park
61	Silver Maple	<i>Acer saccharinum</i>	31	Poor	Save	park
62	Silver Maple	<i>Acer saccharinum</i>	35	Fair	Save	park
63	Tulip Tree	<i>Liriodendron tulipifera</i>	36	Good	Save	park
64	Tulip Tree	<i>Liriodendron tulipifera</i>	37	Fair, twin with 65	Save	park
65	Tulip Tree	<i>Liriodendron tulipifera</i>	38	Fair	Save	park
66	Silver Maple	<i>Acer saccharinum</i>	65	Fair, 4 stems	Save	park
67	Black Cherry	<i>Prunus serotina</i>	40	Poor, damaged	Remove	3
68	Tulip Tree	<i>Liriodendron tulipifera</i>	58	Fair	Save	3
69	Sycamore	<i>Platanus occidentalis</i>	30	Fair	Save	park
70	Silver Maple	<i>Acer saccharinum</i>	40	Fair, 6 stems	Save	park
71	Silver Maple	<i>Acer saccharinum</i>	44	Fair, 4 stems	Save	park
72	Silver Maple	<i>Acer saccharinum</i>	39	Good, stream bank	Save	park
73	Tulip Tree	<i>Liriodendron tulipifera</i>	36	Fair, 3 stems	Save	park
74	Tulip Tree	<i>Liriodendron tulipifera</i>	30	Fair, 3 stems	Save	park
75	Tulip Tree	<i>Liriodendron tulipifera</i>	33	Poor	Save	park
76	Tulip Tree	<i>Liriodendron tulipifera</i>	32	Good	Remove	park
77	Tulip Tree	<i>Liriodendron tulipifera</i>	60	Fair, 3 stems	Save	park
78	Tulip Tree	<i>Liriodendron tulipifera</i>	30	Poor	Save	park
79	Tulip Tree	<i>Liriodendron tulipifera</i>	30	Fair	Save	park
80	Tulip Tree	<i>Liriodendron tulipifera</i>	31	Fair, twin with 81	Save	park
81	Tulip Tree	<i>Liriodendron tulipifera</i>	30	Fair, twin	Save	park
82	Silver Maple*	<i>Acer saccharinum</i>	67	Fair	Save	park
83	Silver Maple	<i>Acer saccharinum</i>	59	Fair	Save	park
84	Silver Maple*	<i>Acer saccharinum</i>	75	Fair	Save	park
85	Silver Maple	<i>Acer saccharinum</i>	50	Good	Save	park
86	Black Walnut	<i>Juglans nigra</i>	34	Fair	Save	park
87	Silver Maple	<i>Acer saccharinum</i>	40	Fair	Save	park
88	Pin Oak	<i>Quercus palustris</i>	38	Good	Save	park
89	Pin Oak	<i>Quercus palustris</i>	30	Good	Save	park
90	Silver Maple	<i>Acer saccharinum</i>	47	Good	Save	park

91	Black Walnut	<i>Juglans nigra</i>	30	Poor	Save	park
92	Black Walnut	<i>Juglans nigra</i>	30	Fair	Save	6
93	Pin Oak	<i>Quercus palustris</i>	32	Good	Save	park
94	Silver Maple	<i>Acer saccharinum</i>	44	Poor, trunk damage	Save	park
95	Pin Oak	<i>Quercus palustris</i>	34	Good	Save	park
96	Cedar	<i>Juniperus sp.</i>	30	Good	Save	4
97	Tulip Tree	<i>Liriodendron tulipifera</i>	34	Fair	Save	4
98	Red Maple	<i>Acer rubrum</i>	34	Fair	Save	4
99	Tulip Tree	<i>Liriodendron tulipifera</i>	45	Good	Save	4
100	Black Locust	<i>Robinia pseudoacacia</i>	36	Poor	Save	4
101	Sweetgum	<i>Liquidambar styraciflua</i>	35	Fair	Save	6
102	Sweetgum	<i>Liquidambar styraciflua</i>	34	Fair	Save	6
103	American Beech	<i>Fagus grandifolia</i>	40	Good	Save	6
104	Red Maple	<i>Acer rubrum</i>	35	Good	Save	6
105	Red Maple	<i>Acer rubrum</i>	30	Fair	Save	6
106	Red Maple	<i>Acer rubrum</i>	52	Poor	Save	6
107	Sweetgum	<i>Liquidambar styraciflua</i>	31	Fair	Save	6
108	Red Maple	<i>Acer rubrum</i>	35	Good	Save	6
109	Tulip Tree	<i>Liriodendron tulipifera</i>	52	Poor	Save	6
109 A	Sweetgum	<i>Liquidambar styraciflua</i>	51	Fair	Save	6
110	Sweetgum	<i>Liquidambar styraciflua</i>	33	Fair	Save	6
111	Sweetgum	<i>Liquidambar styraciflua</i>	37	Good	Save	6
112	Elm	<i>Ulmus sp.</i>	36	Fair	Save	
113	Tulip Tree	<i>Liriodendron tulipifera</i>	35	Fair, twin	Save	4
114	Tulip Tree	<i>Liriodendron tulipifera</i>	37	Good	Save	4
115	Tulip Tree	<i>Liriodendron tulipifera</i>	34	Good	Save	offsite
116	Tulip Tree	<i>Liriodendron tulipifera</i>	41	Good	Save	offsite
117	Tulip Tree	<i>Liriodendron tulipifera</i>	41	Good	Save	offsite
118	Tulip Tree	<i>Liriodendron tulipifera</i>	30	Good	Save	4
119	Tulip Tree	<i>Liriodendron tulipifera</i>	36	Good	Save	4
120	Tulip Tree	<i>Liriodendron tulipifera</i>	38	Fair	Save	4
121	Tulip Tree	<i>Liriodendron tulipifera</i>	32	Fair, twin with 29"	Save	4
122	Tulip Tree	<i>Liriodendron tulipifera</i>	33	Good	Save	4
123	Tulip Tree	<i>Liriodendron tulipifera</i>	32	Fair	Save	offsite
124	Tulip Tree	<i>Liriodendron tulipifera</i>	34	Fair	Save	4
125	Tulip Tree	<i>Liriodendron tulipifera</i>	37	Good	Save	4
126	Elm	<i>Ulmus sp.</i>	36	Fair, twin	Save	4
127	Tulip Tree	<i>Liriodendron tulipifera</i>	41	Fair	Save	4
128	Tulip Tree	<i>Liriodendron tulipifera</i>	31	Fair	Save	4 church
129	Tulip Tree	<i>Liriodendron tulipifera</i>	41	Fair	Save	4 church
130	Tulip Tree	<i>Liriodendron tulipifera</i>	45	Fair, trash in area	Save	4 church
131	Tulip Tree	<i>Liriodendron tulipifera</i>	51	Fair, twin	Save	4 church
132	Tulip Tree	<i>Liriodendron tulipifera</i>	30	Fair	Save	4
133	American Beech	<i>Fagus grandifolia</i>	32	Fair	Save	4
134	American Beech	<i>Fagus grandifolia</i>	32	Fair, trash in area	Save	4
135	Tulip Tree	<i>Liriodendron tulipifera</i>	32	Good	Save	4
136	Tulip Tree	<i>Liriodendron tulipifera</i>	30	Fair, stream bank	Save	4
137	White Oak	<i>Quercus alba</i>	30	Good	Save	4
138	White Oak	<i>Quercus alba</i>	33	Good	Save	4
139	White Oak	<i>Quercus alba</i>	33	Good	Save	4
140	White Oak	<i>Quercus alba</i>	36	Good, stream bank	Save	4
141	Tulip Tree	<i>Liriodendron tulipifera</i>	39	Fair	Save	4
142	White Oak	<i>Quercus alba</i>	34	Good	Save	4
143	Tulip Tree	<i>Liriodendron tulipifera</i>	30	Fair, head of swale	Save	4
144	Tulip Tree	<i>Liriodendron tulipifera</i>	33	Fair	Save	4
145	Tulip Tree	<i>Liriodendron tulipifera</i>	34	Good, stream bank	Save	4
146	Tulip Tree	<i>Liriodendron tulipifera</i>	35	Fair	Save	4
147	Red Oak	<i>Quercus rubra</i>	34	Fair	Save	4
148	Tulip Tree	<i>Liriodendron tulipifera</i>	37	Good	Save	4
149	Tulip Tree	<i>Liriodendron tulipifera</i>	42	Fair	Save	4
150	Tulip Tree	<i>Liriodendron tulipifera</i>	30	Fair	Save	4
151	Tulip Tree	<i>Liriodendron tulipifera</i>	42	Good	Save	4
152	Red Maple	<i>Acer rubrum</i>	33	Poor	Save	5
153	American Beech	<i>Fagus grandifolia</i>	34	Good	Save	5
154	Tulip Tree	<i>Liriodendron tulipifera</i>	36	Good	Save	5
155	American Beech	<i>Fagus grandifolia</i>	30	Good	Save	5
156	Tulip Tree	<i>Liriodendron tulipifera</i>	40	Fair	Save	5
157	White Oak	<i>Quercus alba</i>	34	Fair	Save	5
158	Black Gum	<i>Nyssa sylvatica</i>	30	Fair	Save	5
159	Silver Maple	<i>Acer saccharinum</i>	36	Poor	Save	5
160	Silver Maple	<i>Acer saccharinum</i>	52	Fair	Save	5
161	Red Maple	<i>Acer rubrum</i>	39	Fair	Save	5
162	Red Maple	<i>Acer rubrum</i>	36	Fair	Save	5
163	Norway Maple	<i>Acer platanoides</i>	51	Fair	Save	5
164	Norway Maple	<i>Acer platanoides</i>	34	Fair	Save	5
165	Red Maple	<i>Acer rubrum</i>	35	Poor	Save	5
166	Red Maple	<i>Acer rubrum</i>	31	Fair	Save	6
167	Red Maple	<i>Acer rubrum</i>	30	Poor	Save	6
168	Hickory	<i>Carya sp.</i>	31	Poor	Save	6
169	Black Locust	<i>Robinia pseudoacacia</i>	36	Poor	Save	6
170	Black Locust	<i>Robinia pseudoacacia</i>	30	Fair	Save	park
171	Black Locust	<i>Robinia pseudoacacia</i>	35	Poor	Save	park
172	Silver Maple	<i>Acer saccharinum</i>	46	Fair	Save	park
173	Silver Maple	<i>Acer saccharinum</i>	35	Fair	Save	park
174	Silver Maple	<i>Acer saccharinum</i>	49	Fair	Save	park
175	Tulip Tree	<i>Liriodendron tulipifera</i>	37	Good	Save	park
176	Tulip Tree	<i>Liriodendron tulipifera</i>	34	Fair	Save	park
177	Tulip Tree	<i>Liriodendron tulipifera</i>	35	Fair	Save	park
178	Black Walnut	<i>Juglans nigra</i>	31	Fair	Save	6
179	Black Locust	<i>Robinia pseudoacacia</i>	36	Poor	Save	6

180	Osage Orange*	<i>Maclura pomifera</i>	57	Fair, covered in English Ivy	Save	6
181	Hickory	<i>Carya</i> sp.	33	Fair	Save	6
182	Black Gum*	<i>Nyssa sylvatica</i>	44	Fair	Save	6
183	Black Gum*	<i>Nyssa sylvatica</i>	54	Fair	Save	6
184	Beech	<i>Fagus</i> sp.	43	Fair	Save	6
185	Red Maple	<i>Acer rubrum</i>	30	Good	Save	6
186	Silver Maple	<i>Acer saccharinum</i>	34	Poor	Save	6
187	Black Walnut	<i>Juglans nigra</i>	31	Fair	Save	6
188	Silver Maple	<i>Acer saccharinum</i>	48	Poor	Save	park
189	Silver Maple	<i>Acer saccharinum</i>	42	Fair	Save	park
190	Pin oak	<i>Quercus palustris</i>	30	Good	Save	park
191	Red Maple	<i>Acer rubrum</i>	39	Fair	Save	park
192	Red Oak	<i>Quercus rubra</i>	46	Fair, twin	Save	5
193	Red Oak	<i>Quercus rubra</i>	31	Good	Save	5
194	Red Oak	<i>Quercus rubra</i>	38	Good	Save	5
195	Tulip Tree	<i>Liriodendron tulipifera</i>	40	Good	Save	5
196	White Oak	<i>Quercus alba</i>	50	Fair, stream bank	Save	5
197	Red Oak	<i>Quercus alba</i>	32	Fair	Save	5
198	Tulip Tree	<i>Liriodendron tulipifera</i>	30	Good	Save	5
199	Tulip Tree	<i>Liriodendron tulipifera</i>	32	Good	Save	5
200	Tulip Tree	<i>Liriodendron tulipifera</i>	41	Fair	Remove	1A
201	Number not used					
202	Tulip Tree	<i>Liriodendron tulipifera</i>	30	Fair	Save	1b
203	Tulip Tree	<i>Liriodendron tulipifera</i>	32	Good	Save	1b
204	Tulip Tree	<i>Liriodendron tulipifera</i>	30	Fair	Save	1b
205	Tulip Tree	<i>Liriodendron tulipifera</i>	31	Fair	Save	1b
206	Southern Red Oak	<i>Quercus falcata</i>	36	Fair	Save	1b
207	Black Walnut	<i>Juglans nigra</i>	38	Fair	Save	1b
208	Tulip Tree	<i>Liriodendron tulipifera</i>	43	Fair	Save	1b
209	Tulip Tree	<i>Liriodendron tulipifera</i>	45	Fair	Save	offsite
210	Tulip Tree	<i>Liriodendron tulipifera</i>	31	Fair	Remove	1b
211	Number not used					
212	Tulip Tree	<i>Liriodendron tulipifera</i>	30	Fair	Save	1b
213	Tulip Tree	<i>Liriodendron tulipifera</i>	34	Fair	Save	1b
214	Tulip Tree	<i>Liriodendron tulipifera</i>	41	Fair	Save	1b
215	Black Walnut	<i>Juglans nigra</i>	30	Fair	Save	1a
216	Sycamore	<i>Platanus occidentalis</i>	32	Fair	Save	1a
217	Sycamore	<i>Platanus occidentalis</i>	34	Fair	Save	1a
218	Sycamore	<i>Platanus occidentalis</i>	33	Fair	Save	1a
219	Sycamore	<i>Platanus occidentalis</i>	32	Fair	Save	5
220	Red Maple	<i>Acer rubrum</i>	30	Fair	Save	5
221-225	Numbers not used					
226	Tulip Tree	<i>Liriodendron tulipifera</i>	35	Fair	Save	5
227-230	Numbers not used					
231	Tulip Tree	<i>Liriodendron tulipifera</i>	31	Fair	Save	1A
232	Number not used					
233	Tulip Tree	<i>Liriodendron tulipifera</i>	39	Fair	Save	1a
234-235	Numbers not used					
236	Pin Oak	<i>Quercus palustris</i>	34	Fair	Save	5
237	Sweetgum	<i>Liquidambar styraciflua</i>	31	Fair	Save	5
238	Sweetgum	<i>Liquidambar styraciflua</i>	32	Fair, twin	Save	5
239	Sweetgum	<i>Liquidambar styraciflua</i>	30	Fair	Save	5
240	Number not used					
241	Tulip Tree	<i>Liriodendron tulipifera</i>	38	Fair	Save	5
242	Tulip Tree	<i>Liriodendron tulipifera</i>	37	Fair	Save	5
243	Sycamore	<i>Platanus occidentalis</i>	31	Fair	Save	park
244-245	Numbers not used					
246	Sycamore	<i>Platanus occidentalis</i>	41	Fair	Save	park
247	Tulip Tree	<i>Liriodendron tulipifera</i>	48	Fair	Save	park
248	Silver Maple	<i>Acer saccharinum</i>	45	Fair	Save	park
249	Number not used					
250	Black Walnut	<i>Juglans nigra</i>	34	Poor	Save	park
251-253	Numbers not used					
254	Southern Red Oak	<i>Quercus falcata</i>	34	Fair	Save	park
255	Number not used					
256	Tulip Tree	<i>Liriodendron tulipifera</i>	31	Fair	Save	5
257	Tulip Tree	<i>Liriodendron tulipifera</i>	35	Fair	Save	5
258	Tulip Tree	<i>Liriodendron tulipifera</i>	32	Fair	Save	5
259-261	Numbers not used					
262	American Beech	<i>Fagus grandifolia</i>	30	Fair	Save	5
263	Tulip Tree	<i>Liriodendron tulipifera</i>	31	Fair	Save	5
264	Tulip Tree	<i>Liriodendron tulipifera</i>	33	Fair	Save	5
265	Black Walnut	<i>Juglans nigra</i>	33	Poor	Save	5
266-269	Numbers not used					
270	Tulip Tree	<i>Liriodendron tulipifera</i>	53	Fair	Save	5
271-288	Numbers not used					
289	Tulip Tree	<i>Liriodendron tulipifera</i>	31	Fair	Remove	1a
290	Number not used					
291	Virginia Pine	<i>Pinus virginiana</i>	31	Poor	Remove	1a
292	Tulip Tree	<i>Liriodendron tulipifera</i>	31	Fair	Remove	1a
293-294	Numbers not used					
295	Silver Maple	<i>Acer saccharinum</i>	33	Fair	Remove	infra 1
296-299	Numbers not used					
300	Silver Maple	<i>Acer saccharinum</i>	37	Fair	Remove	1a
301	Tulip Tree	<i>Liriodendron tulipifera</i>	34	Fair	Remove	infra 1
302	Tulip Tree	<i>Liriodendron tulipifera</i>	43	Fair	Remove	1a
303	Southern Red Oak	<i>Quercus falcata</i>	30	Fair	Remove	1a
304	Silver Maple	<i>Acer saccharinum</i>	36	Fair, 2 of 11 stems	Save	1b
305	Silver Maple	<i>Acer saccharinum</i>	34	Fair, 2 of 11 stems	Save	1b
306	Tulip Tree	<i>Liriodendron tulipifera</i>	30	Fair	Save	1b
307-308	Numbers not used					



