TREE CONSERVATION TYPE 2/027/2021 FOR

METRO CITY

SEAT PLEASANT ELECTION DISTRICT NO.18

PRINCE GEORGE'S COUNTY, MARYLAND

PHASE 1 - KEY MAP

I/ We METRO C 1+3/ LLC . hereby acknowledge that we are aware of this Type 2 Come & filewoods, June 4/19/18 / We _____hereby acknowledge that we are aware of this Type 2

Tree Conservation Plan (TCP2) and that we understand the requirements as set forth in this TCP2.

Property Owners Awareness Certificate

METRO CITY SITE NOTES

PARCEL A: HOME OWNER ASSOCIATION - AREA: 329.096 S.F.
 PARCEL A: HOME OWNER ASSOCIATION - AREA.
 3.89.968 S.F.

 PARCEL F: HOME OWNER ASSOCIATION - AREA.
 3.8687 S.F.

 PARCEL G: METRO CITY LLC. - AREA.
 3.679 S.F.

 PARCEL I: METRO CITY LLC. - AREA.
 3.479 S.F.

 PARCEL I: METRO CITY LLC. - AREA.
 3.4892 S.F.

 PARCEL I: M-NOPPC. - AREA.
 25.9041 S.F.

 PARCEL H. METRO CITY LLC. AREA.
 35.479 S. F.

 PARCEL E. METRO CITY LLC. AREA.
 23.980 S. F.

 PARCEL E. M. MCPPC. AREA.
 25.901 S. I.

 PARCEL I. HOME OWNER ASSOCIATION - AREA.
 2.996 S. F.

 PARCEL N. HOME OWNER ASSOCIATION - AREA.
 2.996 S. F.

 PARCEL C. HOME OWNER ASSOCIATION - AREA.
 2.200 S. F.
 LOTS 1 THROUGH 72 : METRO CITY LLC. - AREA: 141,898 S.F. RIGHT OF WAY DEDICATION:

1.080.817 S.F

- ZONING: MIXED LISE TRANSPORTATION ORIENTED M-X-T
- NUMBER OF LOTS: 10 PARCELS AND 72 LOTS. GROSS FLOOR AREA: 498,977 S.F.
- 200 (WSSC) FOOT MAP REFERENCE: 202SE06 TAX MAP NUMBER AND GRID:ADC:073/C3
- AVIATION POLICY AREA: N/A
- WATER/SEWER EXISTING: \$-3/W-3 WATER/SEWER EXISTING: S-3/W-3
- STORM WATER MANAGEMENT APPROVAL: #48903-2016 APPROVAL DATE: 11/15/20
- 10. 10-FOOT PUBLIC UTILITY ALONG ALL RIGHT-OF-WAYS
 MANDATORY PARK DEDICATION: EXEMPT PER SECTION 24-134(A)(3)
 THERE ARE NOT CEMETERIES CONTIGUOUS TO THE PROPERTY.
- 13. THERE ARE NOT HISTORIC SITES ON OR IN THE VICINITY OF THE PROPERTY THERE ARE WATER OF THE USA AND WETLANDS ON SITE
- THIS PROPERTY IS NOT WITH IN CHESAPEAKE BAY CRITICAL AREA OVERLAY.
 SOURCE OF TOPOGRAPHY: CAPITOL DEVELOPMENT DESIGN INC.

- 23. HORIZONTAL DATUM IS THE MARYLAND PLANE COORDINATE SYSTEM (NAD83)
- 24. DURING THE CONSTRUCTION OF THIS PROJECT. NO DUST SHOULD BE ALLOWED TO CROSS OVER PROPERTY LINES AND IMPACT ADJACENT PROPERTIES. INDICATE INTENT TO CONFORM TO CONSTRUCTION ACTIVITY DUST CONTROL REQUIREMENTS AS SPECIFIED IN THE 2011
- ADJACENT PROPERTIES. INDICATE INTENT TO CONFORM TO CONSTRUCTION ACTIVITY NOISE CONTROL REQUIREMENTS AS SPECIFIED IN SUBTITLE 19 OF THE PRINCE GEORGE'S COUNTY

QUALIFIED PROFESSIONAL CERTIFICATION THIS PLAN COMPLIES WITH THE CURRENT REQUIREMENTS OF SUBTITLE 25 AND THE WOOD LAND WILDLIFE

POWDER MILL ROAD - SUITE 200 - BELTSVILLE, MD 20705 PHONE (301) 937-3501, EMAIL:PEREZ@CDDI.NET

APPLICANT ROCKVILLE, MD. 20852 PHONE # 301-467-5536 E-MAIL: AGIDEVCO@VERIZON.NET

SHEET INDEX SHEET NO. PLAN TYPE

COVER SHEET
TREE CONSERVATION PLAN SHEET TREE CONSERVATION PLAN SHEET TREE CONSERVATION PLAN SHEET TREE CONSERVATION PLAN SHEET TREE CONSERVATION PLAN SHEET TREE CONSERVATION PLAN SHEET

DETAIL SHEET 1 DETAIL SHEET 2

THE MARYI AND-NATIONAL CAPITAL PARK AND PLANNING COMMISSION FOR OFFICIAL USE ONLY APPLICATION NAME: METRO CITY APPLICATION NO.: DSP-20012 TCP NO.: TCP2-027-2021 SIGNATURE APPROVAL OF THIS PLAN IS IN ACCORDANCE WITH PGCPB RESOLUTION NO. 2022-11 DATED FEBRUARY 10, 2022. SIGNATURE APPROVAL DATE: Fothergill, Anne



DESIGN, INC. - SURVEYOR'S

DEVELOPMENT
- PLANNERS

CAPITOL ENGINEERS

1,000 ROLLINS AVE.
PLEASANT (18TH) ELECTION DISTRICT
INCE GEORGE'S COUNTY, MARYLAND

ETRO CITY ROLLINS A

,000

SHEET

COVER

REVISIONS

10/11/2021 REV

MAP

TCP2/027/2021

SUITE 200

VICINITY MAP SCALE: 1"= 2000"

STORWALTER MANAGEMENT FACULTY WOODLAND PRESERVED-NOT WOODLAND RETAINED-ASSUMED CLEARED - LIMIT OF DISTURBANCE TREE PROTECTION FENC (TEMPORARY) OST SPECIMEN THESES TO HE SAVES ST SPECIMEN TREES FOR REMOVE

METRO CITY IS A PRIORITY **ONE PROJECT**

| | Prince Geo | rge's County Pl | lanning Departme | ent, M-NCPPC | | |
|----|----------------------|-----------------|---------------------|--|-----------|---------|
| | | Environment | al Planning Section | on . | | |
| | TREE | CONSERVAT | TION PLAN AF | PPROVAL. | | |
| | | | 2 -027- 2021 | | | |
| _ | Approved by | Date | DRD# | Reason for Revision | | |
| 00 | Alexander Kirchkof | 9-27-2022 | DSP-20012 | | DATE: OC | T, 2020 |
| 01 | | | | | DWN. | CHECKED |
| 02 | | | | | JK | MT |
| 03 | | | | | | |
| 04 | | | | | SCALE: | SHOWN |
| 05 | | | | | | SHOWN |
| 06 | | | | | PROJECT/F | TLE NO. |
| | | | | nt of woodland conservation vildlife habitat conservation | 1 | 15-026 |
| | ent recorded in Prin | nce George's Co | ounty Land Recor | rds at Liber 47970, Folio 304 | SHEET NO. | |

MISS UTILITY
FOR LOCATION OF UTILITIES CALL 1-800-257-7777
48 HOURS IN ADVANCE OF ANY WORK IN THE VICINIT

21. APPLICANT/OWNER:

METRO CITY LLC 10701 LADY SLIPPER TERRACE ROCKVILLE, MD, 20852

PHONE # 301-467-5536 E-MAIL : AGIDEVCO@VERIZON.NET


22. THERE ARE STEEP SLOPES ON SITE AND THE VERTICAL DATUM IS THE NAVD 88.


MARYLAND STANDARDS AND SPECIFICATIONS FOR SOIL EROSION AND SEDIMENT CONTROL. 25. NO CONSTRUCTION NOISE SHOULD BE ALLOWED TO ADVERSELY IMPACT ACTIVITIES ON THE


FUTURE PHASE


> **PLAN VIEW** 1"=125' GRAPHIC SCALE


(IN FEET) 1 inch = 125 ft.

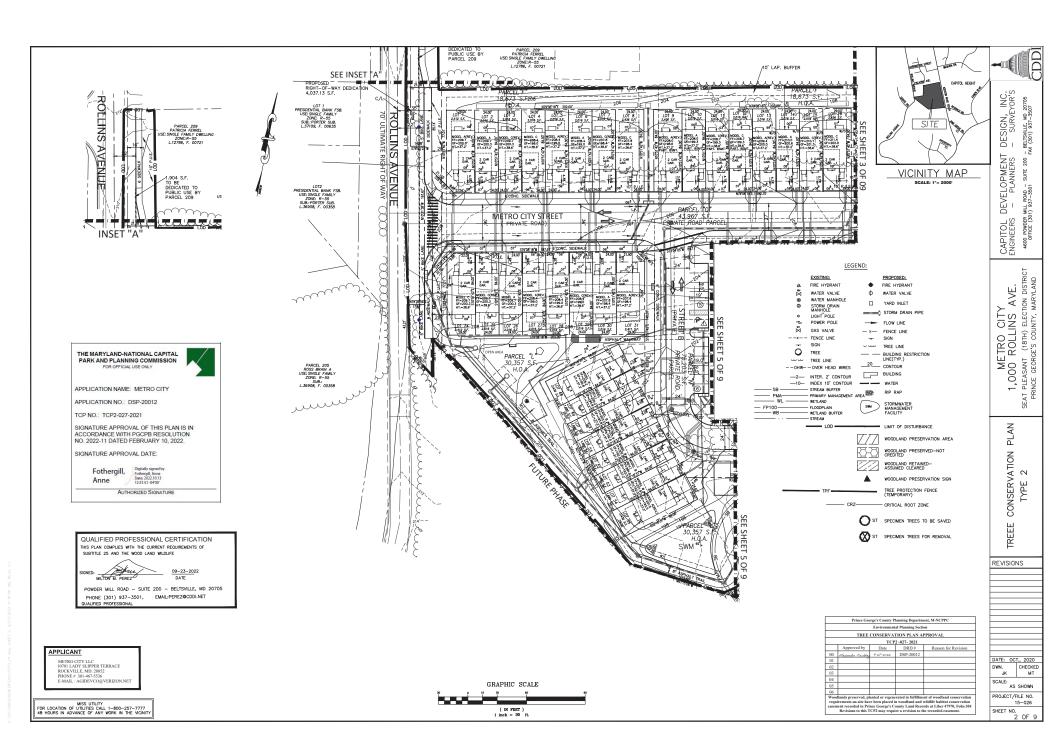


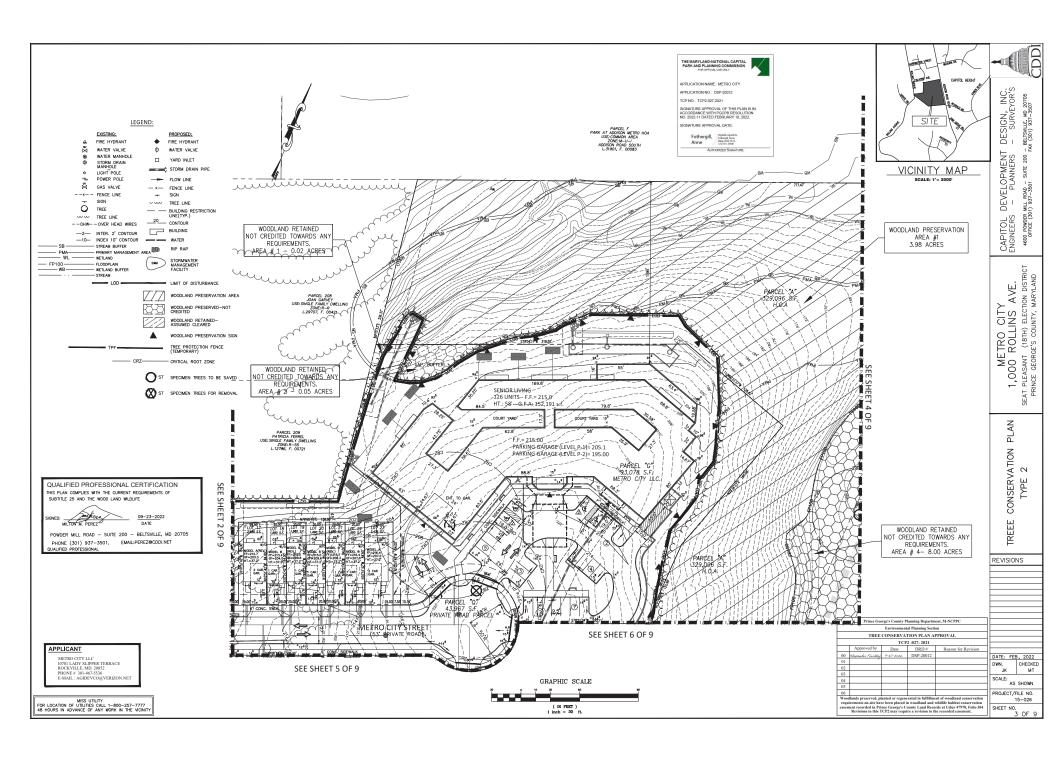

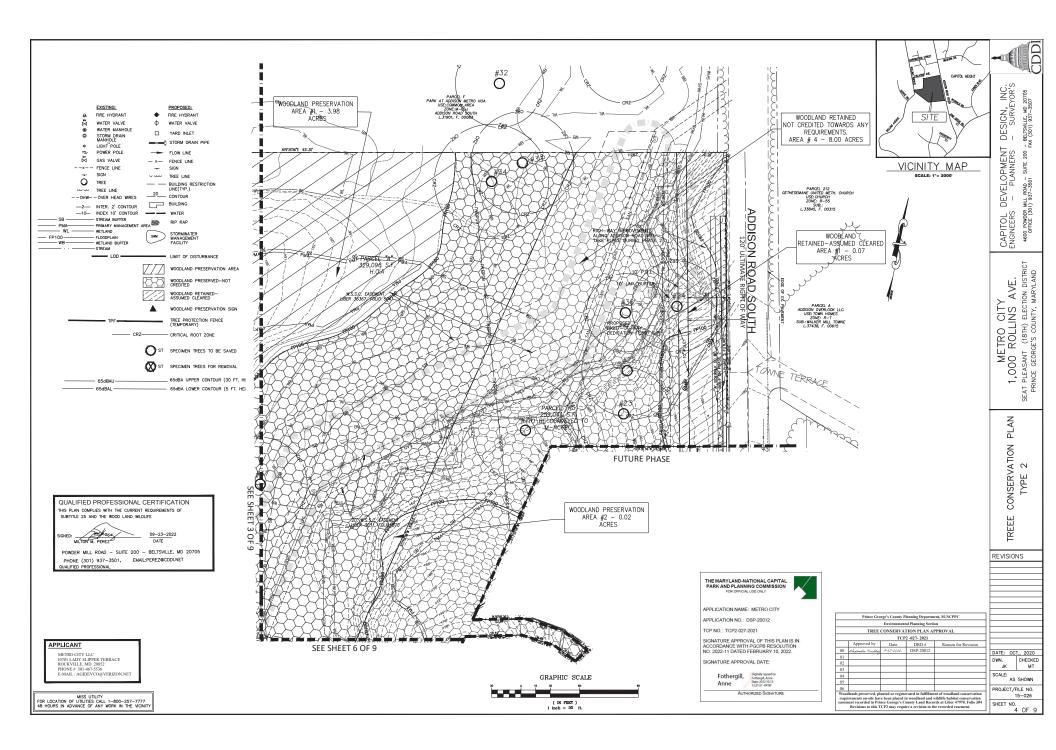

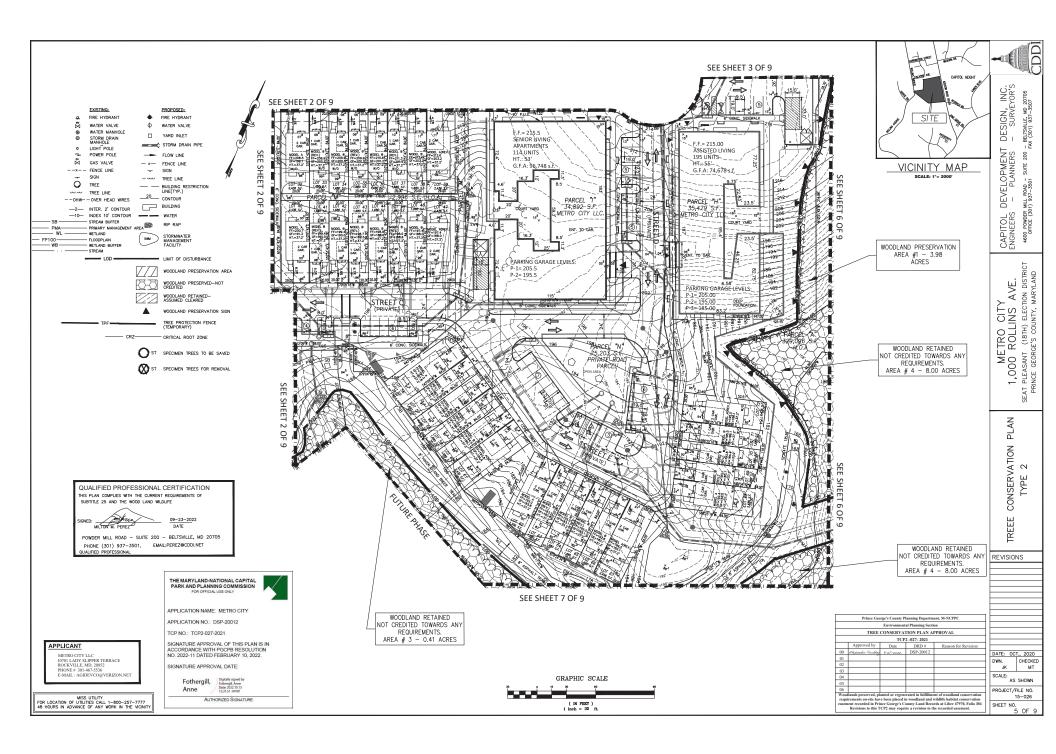

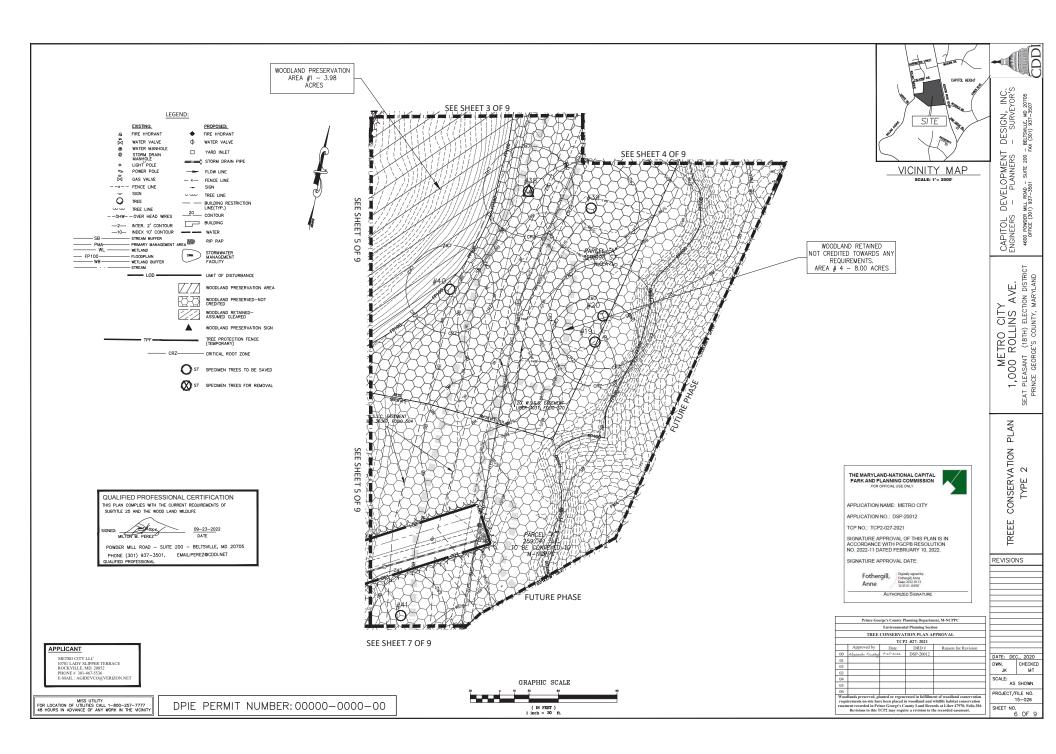

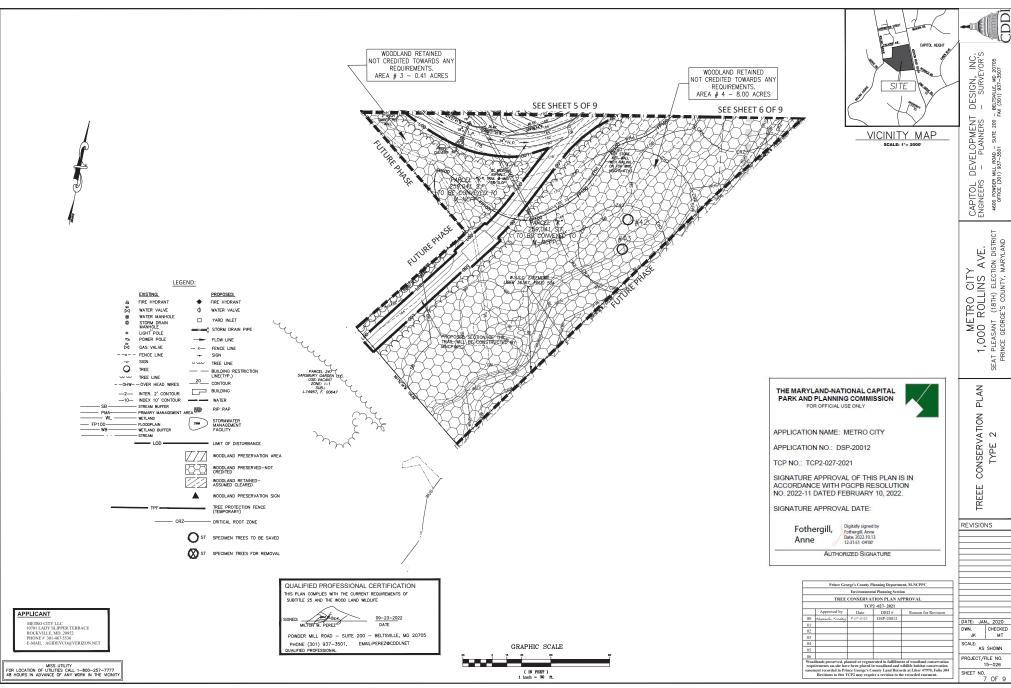

- This plan is submitted to fulfill the woodland conservation requirements for a <u>Detailed Site Plan</u> 20012.

- The developer or builder of the lots or parcels shown on this plan shall notify future buyers of any woodland conservation areas through the provision of a copy of this plan at time of contract signing. Future properly owners are also subject to this requirement.
- 6. The property is within the Developed Tier and is zoned M-X-T.

- a. All woodlands designated on this plan for preservation are the responsibility of the property owner. The woodland areas shall remain in a natural state. This includes the canopy trees and understopy vegetation. A revised the conversation plan is required price to clearing woodland areas that are not specifically identified to be cleared on the approved TCP2.

- Removal of Hazardous Trees or Limbs by Developers or Builders
- The developer and/or builder is responsible for the complete preservation of all forested areas shown on the approved plan to remain undisturbed. Only trees or parts thereof designated by the county as dead, dying, or hazardous may be removed.

If corrective pruning may alleviate a hazardous condition, the Certified Arborist or a Licensed Tree Expert may proceed without further authorization. The pruning must be done in accordance with

Debris from the tree removal or pruning that occurs within 35 feet of the woodland edge may be removed and properly disposed of by recycling, chipping or other acceptable methods. All destire that is more than 35 feet from the woodland edge shall be out up to allow contact with the ground thus encouraging decomposition. The smaller materials shall be placed into brush piles that will serve as weldfer habitat.

Tree work to be completed within a road right-of-way requires a permit from the Maryland Department of Natural Resources unless the tree removal is shown within the approved limits of disturbance on a TCP2. The work is required to be conducted by a Licensed Tree Expert.

If development is proposed to be completed in phases:

If existing trees are proposed for use as protection for preservation areas:

Debris piles shown in woodland preservation areas shall be removed by hand without the use of mechanical equipment within the preservation area. Chains may be used to pull debris out of the preservation areas. Caution must be used not to damage remaining vegetation.

If We METRO C 172 LLC bereby acknowledge that we are aware of this Type 2

Tree Conservation Plan (TCP2) and that we understand the requirements as set forth in this TCP2. Cure & folewards, Mala 4/19/18

APPLICANT

METRO CITY LLC 10701 LADY SLIPPER TERRACE ROCKVILLE, MD. 20852

MISS UTILITY
FOR LOCATION OF UTILITIES CALL 1-800-257-7777
48 HOURS IN ADVANCE OF ANY WORK IN THE VICINITY

When woodlands and/or specimen, historic or champion trees are to remain:

a. If the developer or builder no longer has an intenset in the property and this new owner deserves to immore a latarization set our protein heard. The new owner that dollars a written deserve to immore a latarization set on the proposed contractive massers give to heard proposed contraction and the proposed contractive massers give to heard pink event conducted. Yet proposed contractive has been completed give the heard of tablescent for Prince Georgies Country Property Georges Property Property Country Property Country Country Property Country Country Country Property Country C

In a tree or portions thereof are in imminent danger of striking a structure, parking area, or other high use area and may result in personal injury or property damage them the certification is not required and the permise shall take corrective action inmediately. The condition of the area shall be fully documented through photographs prior to corrective action being taken. The photos shall be submitted to the inspector for documentation of the damage.

- The use of broadcast spraying of herbidides is not permitted. However, the use of herbidides to discourage re-sprucing of invasive, notious, or non-native plants is permitted if done as an application of the chemical directly be the cut shump immediately following cutting of plant tops. The use of any herbidides half be done in accordance with the label instructions.

ISECTION 1. Establishing Site Information (Enter scree for each most)

| WOODLAND CO | INSERVATION SUMMARY TABLE- PHASE 1 |
|---------------------|-------------------------------------|
| RESERVATION AREAS: | |
| REA #1 | 3.98 |
| REA #2 | 0.02 |
| UB-TOTAL | 4.00 |
| OODLAND RETAINED NO | T CREDITED TOWARD ANY REQUIREMENTS: |
| REA #1 | 0.02 |
| REA #2 | 0.05 |
| REA #3 | 8.00 |
| REA #4 | 0.41 |
| | |
| UB-TOTAL | 8.48 |
| OODLAND RETAINED CO | UNTED AS CLEAR: |
| REA #1 | 0.07 |
| UB-TOTAL | 0.07 |
| OTAL | 12.55 |

| SITE STATISTICS | TOTAL |
|---|----------|
| Gross tract area | 39.67 Ac |
| Existing 100-year floodplain | 10.36 Ac |
| Net tract area | 29.30 Ac |
| Existing woodland in the floodplain | 10.36 Ac |
| Existing woodland net tract | 26.24 Ac |
| Existing woodland total | 36.60 Ac |
| Existing PMA | 20.56 Ac |
| Regulated streams (linear feet of centerline) | 3,256 Lf |
| | |

SIGNATURE APPROVAL DATE: Fothergill, Digitally signed by Fothergill, Anne Date: 2022 18:15 14:2015 1-04:00

Phased Woodland Conservation Worksheet for Prince George's County

| Zone: | M-X-T | | | |
|--|------------------|-------------------|--------------|--|
| Gross Tract: | 39.67 | | | Include acreages only in columns |
| Floodplain: | 10.36 | | | for which there is a corresponding zone. |
| Previously Dedicated Land: | 0.00 | | | |
| Net Tract (NTA): | 29.31 | 0.00 | 0.00 | 1 |
| TCP II or 2 Number | 2-027-2021 | Revision | | |
| Property Description or Subdivision Name: | METRO CIT | / | | |
| TCP1 Number | TCP1-004-2 | 017 | | |
| Is this site subject to the 1989 Ordinance? (Y/N) N | 2010 | Ordinance? (Y/N) | N | Within PEA (Y/N) Y |
| Break-even Point (preservation acres) = 8 | 77 | | | |
| Acres of Net Tract clearing permitted w/o reforestion= 17 | 47 | | | |
| | _ | | | |
| SECTION II - Determining Woodland Conservation Requirement | nts (Enter acres | for each correspo | nding columi | 1) |
| Existing Woodland on Net Tract (acres) | 26.24 | | | |
| Existing Woodland in Floodplain (acres) | 10.36 | | | |
| Woodland Conservation Threshold (NTA) = 15.009 | 6 4.40 | 1 | | |
| Smaller of 10 or 12 | 4.40 | | | |
| Woodland above WCT | 21.84 | | | |
| Plan Number: (This must be completed for each phase) | DSP-20012 | DSP | | |
| Revision Number | 0 | 0 | | |
| Plan Phase or Name: | PHASE 1 | FUTURE PHASE | | |
| | | | | |


| | SECTION II - Determining Woodland Conservation Requiremen | | | | | | | |
|----|--|-----------|--------------|--------------|------|------|------|-------|
| | | | | naing column | 1 | | | |
| | Existing Woodland on Net Tract (acres) | 28.24 | | | | | | |
| | Existing Woodland in Floodplain (acres) | 10.36 | | | | | | |
| | Woodland Conservation Threshold (NTA) = 15.00% | | | | | | | |
| | Smaller of 10 or 12 | 4.40 | | | | | | |
| | Woodland above WCT | 21.84 | | | | | | |
| | Plan Number: (This must be completed for each phase) | DSP-20012 | DSP | | | | | |
| | Revision Number | 0 | 0 | | | | | |
| 19 | Plan Phase or Name: | PHASE 1 | FUTURE PHASE | | | | | |
| 20 | TCP2 Number for this Phase or Section | 027-2021 | 0-000-00-00 | | | | | |
| | Revision Number | 0 | 0 | | | | | |
| 22 | Status | PENDING | PENDING | | | | | |
| 23 | Approval Date | | | | | | | Total |
| 24 | Total area in this application (acres) | 24.81 | 14.86 | 0.00 | 0.00 | 0.00 | 0.00 | 39 |
| 25 | Floodplain area in this application (acres) | 7.06 | 3.30 | 0.00 | 0.00 | 0.00 | 0.00 | 10 |
| 26 | Net Tract area in the application (acres) | 17.75 | 11.56 | | | | | 29 |
| 27 | Woodland on the Net Tract for this phase (acres) | 14.53 | 11.71 | 0.00 | 0.00 | 0.00 | 0.00 | 26 |
| 28 | Woodland in the Floodplain for this phase | 7.06 | 3.30 | 0.00 | 0.00 | 0.00 | 0.00 | 10. |
| 29 | Woodland Cleared on Net Tract for this phase | 8.76 | 6.52 | 0.00 | 0.00 | 0.00 | 0.00 | 15. |
| 30 | Woodland Cleared in Floodplain for this phase | 0.08 | 0.19 | 0.00 | 0.00 | 0.00 | 0.00 | 0. |
| 31 | Off-site Woodland Clearing (1:1) | 0.00 | 0.00 | 0.00 | 0.00 | 0.00 | 0.00 | 0. |
| 32 | Off-site WCA being provided on this property (preservation) | 0.00 | 0.00 | 0.00 | 0.00 | 0.00 | 0.00 | 0. |
| 33 | Off-site WCA being provided on this property (affireforestation) | 0.00 | 0.00 | 0.00 | 0.00 | 0.00 | 0.00 | 0. |
| | Cummulative acres of Net Tract Woodland cleared | 8.76 | 15.28 | - | | | | |
| 35 | Cummulative acres of Floodplain woodland cleared | 0.08 | 0.27 | , | | | | |
| 36 | Smaller of 14 or 26 | 8.76 | 15.28 | | | | | |
| 37 | Woodland Clearing below WCT | 0.00 | | | | | | |
| | Clearing below WCT (2:1 replacement requirement) | 0.00 | 0.00 | | | | | |
| | Replacement for clearing above the WCT (0.25:1) | 2.19 | | | | | | |
| | Replacement for clearing below the WCT (2:1) | 0.00 | | | | | | |
| | Afforestation Required Threshold (AFT) = 15.00% | | | | | | - | |
| | Cumulative Woodland Conservation Required | 6.67 | | | | | - | |

| | | Latest phase | indicates cumula | tive requirem | ent through th | at phase of v | vork | | | |
|----|--|--------------|------------------|---------------|----------------|---------------|------|-------|-------------|--------|
| | SECTION III - Meeting the Requirements | | | | | | | Total | 1 | |
| | Woodland Presenation | 4.00 | 3.54 | | | 0.00 | 0.00 | | | |
| | Afforestation/Reforestation | | | | 0.00 | | | | Bond amount | \$0.00 |
| 43 | Natural Regeneration | | | | | | | 0.00 | ēl . | |
| | Landscape Credits | | | | | | | 0.00 | a) | |
| 45 | Specimen & Historic Tree (CRZ area) | | 0.00 | | | | 0.00 | | 1 | |
| | Specimen & Historic Tree Credit | | | | | | | 0.00 | d . | |
| 46 | Forest Enhancement Acreage | | | 0.00 | | | | |] | |
| | Forest Enhancement Credit (25% of enhancement area) | | _ | | · | | | 0.00 | ēl . | |
| | Street Tree Credit (Existing or 10-year canopy) | | 0.00 | | | | | 0.00 | a a | |
| | Area approved for fee-in-lieu | | | | 0.00 | | 0.00 | | Fee amount: | \$0.00 |
| | Off-site Woodland Conservation Credits Required | | 0.95 | | | | 0.00 | | | |
| | Off-site WCA (preservation) being provided on this property | 0.00 | 0.00 | 0.00 | 0.00 | 0.00 | 0.00 | 0.00 | | |
| | Off-site WCA (afforestation) being provided on this property | 0.00 | | 0.00 | 0.00 | 0.00 | 0.00 | | | |
| 53 | Cummulative Woodland Conservation Provided | 4.00 | 8.49 | | | | | 8.49 | 1 | |
| | | | | | | | | | | |
| | Woodland saved on this phase but not counted | 1.77 | 1.65 | | | | | 3.42 | | |
| | Existing Net Tract Woodland in later phases | 11.71 | 0.00 | | | | | | | |
| 56 | Requirement Status per Phase | | \sim | | | | | | | |
| | | | | | | | | | | |

SOFTENEY THIS PLAN IS IN ACCORDANCE WITH THE FOLLOWING VARIANCE FROM THE STRICT REQUIREMENTS OF SUBTILE 25-122(5)(1)(6), APPROVED BY THE FLANMING BOARD ON FEBRUARY 28, 2018 FOR THE RELOVANT OF THE FOLLOWING SPECIALS THE STREET STAFF, A 25-MICH TURP FOR AT 15-MICH ADVISOR OF THE FOLLOWING THE FORM OF THE FOLLOWING STAFF, A 25-MICH TURP FOR A 15-MICH ADVISOR OF THE FOLLOWING STAFF, A 25-MICH ADVISOR OF THE

QUALIFIED PROFESSIONAL CERTIFICATION THIS PLAN COMPLIES WITH THE CURRENT REQUIREMENTS OF SUBTITLE 25 AND THE WOOD LAND WILDLIFF

POWDER MILL ROAD - SUITE 200 - BELTSVILLE, MD 20705 PHONE (301) 937-3501, EMAIL:PEREZ@CDDI.NET

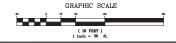

SPECIMEN TREE SUMMARY TABLE

| | | | Diameter | | | | | | | |
|-------|-------------------|-------------------------|-------------|------|--|---------------|------------|-------------|---------|--------------|
| Tree# | Common Name | Latin Name | (DBH) in. | | Comments | Disposition | Inside PMA | Outside PMA | PHASE 1 | FUTURE PHASE |
| 9 | American beech | Fagus gradifolia | 31" | Fair | Fair, larve cavity in trunk, some dead limbs | To be saved | YES | NO. | NO. | YES |
| 10 | Tulip tree | Liriodendron tulipifera | 33" | Good | Good, some vines | Removed* | YES | NO NO | NO NO | YES |
| - 11 | American beech | Fagus gradifolia | 31" | Good | Good, cavity in trunnk | To be saved | YES | NO. | NO NO | YES |
| 12 | American beech | Fagus gradifolia | 30" | Good | | To be saved | YES | NO. | NO. | YES |
| 13 | American beech | Fagus gradifolia | 41" | Good | | To be saved | YES | NO. | NO NO | YES |
| 16 | Tulip tree | Liriodendron tulipifera | 34" | Good | | To be saved | YES | NO NO | NO NO | YES |
| 17 | Tulip tree | Liriodendron tulipifera | 32" | Good | Good, some vines | To be saved | YES | NO | NO NO | YES |
| 18 | Tulip tree | Liriodendron tulipifera | 30" | Good | | To be saved | YES | NO. | NO NO | YES |
| 19 | Tulip tree | Liriodendron tulipifera | 30" | Good | | To be saved | YES | NO. | YES | NO NO |
| 20 | Tulip tree | Linodendron tulipifera | 36" | Good | | To be saved | YES | NO | YES | NO NO |
| 21 | American beech | Fagus gradifolia | 36" | Good | Good, on stream bank | To be saved | YES | NO NO | YES | NO NO |
| 22 | Northern Red Oak | Quereus rubra | 31" | Good | | To be saved | YES | NO. | YES | NO NO |
| 23 | Tulip tree | Linodendron tulipifera | 32" | Good | | To be saved | YES | NO | YES | NO NO |
| 24 | Tulip tree | Liriodendron tulipifera | 31" | Good | | To be saved | YES | NO NO | YES | NO NO |
| 33 | American sycamore | Platanus occidentalis | 35" | Good | Good, moderate vines | To be saved | YES | NO NO | YES | NO NO |
| 34 | American sycamore | Platanus occidentalis | 39" | Good | Good, some vines | To be saved | YES | NO. | YES | NO NO |
| 36 | Tulip tree | Linodendron tulipifera | 30, 17, 16" | Good | Triple trunk | To be saved | YES | NO | YES | NO. |
| 37 | Tulip tree | Liriodendron tulipifera | 32" | Good | | To be saved | YES | NO. | YES | NO NO |
| 38 | Tulip tree | Liriodendron tulipifera | 31" | Good | Good, on stream bank | Removed* | YES | NO NO | YES | NO NO |
| 39 | Tulip tree | Linodendron tulipifera | 33, 20" | Good | Double trunk | To be saved | YES | NO NO | YES | NO NO |
| 40 | Tulip tree | Liriodendron tulipifera | 30" | Good | | To be saved | YES | NO. | YES | NO NO |
| 41 | Northern Red Oak | Quercus rubra | 31" | Fair | borer damaged | To be saved | YES | NO NO | YES | NO NO |
| 42 | Tulip tree | Liriodendron tulipifera | 48" | Good | | To be saved | YES | NO. | YES | NO NO |
| 43 | American sycamore | Platanus occidentalis | 30" | Fair | Fair, extensive vines | To be saved | YES | NO | YES | NO NO |
| 45 | Tulip tree | Liriodendron tulipifera | 30" | Good | Some dead limbs | To be removed | YES | NO. | NO. | YES |
| 46 | Tulip tree | Liriodendron tulipifera | 32" | Good | | To be removed | NO | YES | YES | NO NO |
| 47 | Tulip tree | Linodendron tulipifera | 50" | Good | | To be removed | NO NO | YES | YES | NO NO |
| | | | | | | | | | | |
| | | | | | | | | | | |
| | | | | | | | | | | |

E/15026/DOCUMENTS/ENV/TOPIESPECIMEN TREE SUMMARY TABLE 109/3/s

| | | SPECIMEN TREE ST | UMMAR | YTABLE | (OFF-SITE) | | | | | |
|--------|-------------------|-------------------------|-----------|-----------|------------|-------------|------------|-------------|---------|--------------|
| | | | Diameter | | | | | | | |
| Tree # | Common Name | Latin Name | (DBH) in. | Condition | Comments | Disposition | Inside PMA | Outside PMA | PHASE I | FUTURE PHASE |
| 14 | Tulip tree | Liriodendron tulipifera | 31" | Good | | To be saved | YES | NO NO | NO NO | YES |
| 15 | American sycamore | Platanus occidentalis | 32" | Good | | To be saved | YES | NO NO | NO NO | YES |
| 28 | American sycamore | Platames occidentalis | 31" | Good | | To be saved | YES | NO. | YES | NO NO |

* REMOVAL OF SPECIMEN TREES GRANTED UNDER THE APPROVED BEAVERDAM BRANCH BASIN FOREST CONSERVATION PLAN (APPROVED AND REVISED ON FEBRUARY 2014)

| | | | | WOODLA | ND CONSER | VATION SUMMAR | RY TABLE (TCP | 2) PHASE 1 AND 2 | ! | | | |
|----------------|-------------------------------|------------------------------|--------------------------------------|--|-----------|--|---|--|---|--|--|---|
| PARCEL# | Gross Track Area (sq. ft.) | 100-Yr Floodplain (FP) | Net Track Area (sq. ft.) (NTA) | Existing Woodland (sq. ft.)(NTA) | | Woodland Cleared (sq. ft.) (C-NTA) | Woodland Cleared Floodplain (C-FP) | Woodland Cleared Off-site (C-OS) | Woodland Pres. Area. (sq. ft.) (WPA) | Woodland Reforest. Area (sq. ft.) (WRA) | Woodland Retained/Not Credited (WR- NC) | Woodland Retained / Assumed Cleare (WR-AC) |
| PARCEL "A" | 329,096 | 140,130 | 188,966 | 189,151 | 139,877 | 22,056 | | - | 164,542 | - | 140,130 | - |
| PARCEL "B" | 232,884 | 115,408 | 117,476 | 117,027 | 115,408 | 2,312 | | - | 113,267 | | 115,403 | |
| PARCEL "C" | 68,818 | 1,454 | 67,364 | 66,148 | 1,454 | 0 | - | | 0 | | 0 | - |
| PARCEL "D" | 111,489 | | 111,489 | 111,489 | | 89,247 | | - | 20,546 | - | 1,694 | 1,618 |
| PARCEL "E" | 62,978 | 625 | 62,352 | 62,110 | 625 | 62,110 | 625 | - | | - | - | - |
| PARCEL "F" | 18,687 | - | 18,687 | 13,086 | | 13,086 | | - | - | - | - | - |
| PARCEL "G" | 93,078 | | 93,078 | 92,991 | | 83,095 | | - | 6,908 | | 3,120 | - |
| PARCEL "H" | 35,479 | | 35,479 | 34,970 | | 30,285 | - | - | 2,673 | - | - | - |
| PARCEL "I" | 34,892 | | 34,892 | 35,545 | | 35,545 | - | - | | - | - | - |
| PARCEL"J" | 39,115 | | 39,115 | 38,684 | | 29,202 | - | - | 9,468 | - | - | - |
| PARCEL'K" | 259,041 | 167,369 | 91,672 | 91,801 | 167,518 | 22,170 | 3,679 | | | | 224,429 | 3,004 |
| PARCEL"L" | 30,410 | | 30,410 | 25,280 | | 25,280 | - | - | - | - | 1,719 | - |
| PARCEL "M" | 2,996 | - | 2,996 | 575 | - | 575 | - | - | | - | - | - |
| PARCEL "N" | 75,203 | | 75,203 | 55,894 | | 55,894 | - | - | | - | - | - |
| PARCEL "O" | 36,286 | 19,181 | 17,105 | 17,146 | 19,182 | 4,326 | 2,533 | - | 11,185 | - | 16,691 | 1,618 |
| PARCEL'P" | 58,939 | 3,241 | 55,698 | 55,574 | 3,241 | 55,574 | 3,241 | | | | | |
| PARCEL "Q" | 44,020 | - | 44,020 | 13,332 | | 13,332 | | | | | - | |
| LOTS 1-39 | 79,054 | - | 79,054 | 32,761 | | 32,762 | - | - | | - | - | - |
| LOTS 40-72 | 62,844 | | 62,844 | 46,005 | | 46,006 | | - | | - | - | - |
| ROW DEDICATION | 52,615 | 4,000 | 48,615 | 43,523 | 4,000 | 42,800 | 1,649 | - | | | - | 5,530 |
| TOTAL S.F.: | 1,727,924 | 451,409 | 1,276,515 | 1,143,091 | 451,306 | 665,659 | 11,728 | - | 328,589 | - | 503,187 | 11,769 |
| TOTAL ACRES: | 39.67 | 10.36 | 29.31 | 26.24 | 10.36 | 15.28 | 0.27 | - | 7.54 | - | 11.55 | 0.27 |

| | | | | woo | DLAND CONS | SERVATION SUMP | AARY TABLE (1 | CP 2) PHASE 1 | | | | |
|----------------|-------------------------------|------------------------------|--------------------------------------|--|------------|--|---|--|---|--|--|--|
| PARCEL# | Gross Track Area (sq. ft.) | 100-Yr Floodplain (FP) | Net Track Area (sq. ft.) (NTA) | Existing Woodland (sq. ft.)(NTA) | | Woodland Cleared (sq. ft.) (C-NTA) | Woodland Cleared Floodplain (C-FP) | Woodland Cleared Off-site (C-OS) | Woodland Pres. Area. (sq. ft.) (WPA) | Woodland Reforest. Area (sq. ft.) (WRA) | Woodland Retained/Not Credited (WR- NC) | Woodland Retained / Assumed Clear (WR-AC) |
| PARCEL "A" | 329,096 | 140,130 | 188,966 | 189,151 | 139,877 | 22,056 | 0 | - | 164,542 | - | 140,130 | - |
| PARCEL "F" | 18,687 | | 18,687 | 13,086 | 0 | 13,086 | 0 | | - | | - | - |
| PARCEL "G" | 93,078 | - | 93,078 | 92,991 | - | 83,095 | - | - | 6,908 | - | 3,120 | - |
| PARCEL "H" | 35,479 | - | 35,479 | 34,970 | - | 30,285 | | - | 2,673 | - | - | - |
| PARCEL "I" | 34,892 | 0 | 34,892 | 35,545 | 0 | 35,545 | - | - | - | - | - | - |
| PARCEL'K" | 259,041 | 167,369 | 91,672 | 91,801 | 167,518 | 22,170 | 3,679 | 0 | 0 | 0 | 224,429 | 3,004 |
| PARCEL "L" | 30,410 | - | 30,410 | 25,280 | - | 25,280 | | - | | - | 1,719 | - |
| PARCEL "M" | 2,996 | - | 2,996 | 575 | - | 575 | | - | 0 | - | - | - |
| PARCEL "N" | 75,203 | 0 | 75,203 | 55,894 | 0 | 55,894 | | | 0 | - | - | - |
| PARCEL "Q" | 44,020 | - | 44,020 | 13,332 | 0 | 13,332 | 0 | 0 | 0 | 0 | - | 0 |
| LOTS 1-39 | 79,054 | - | 79,054 | 32,761 | 0 | 32,762 | | - | 0 | - | - | - |
| LOTS 40-72 | 62,844 | | 62,844 | 46,005 | 0 | 46,006 | - | | 0 | - | - | - |
| ROW DEDICATION | 16,017 | | 16,017 | 1,500 | | 1,500 | | | | - | - | |
| TOTAL S.F.: | 1,080,817 | 307,499 | 773,318 | 632,891 | 307,395 | 381,587 | 3,679 | - | 174,123 | - | 369,399 | 3,004 |
| TOTAL ACRES: | 24.81 | 7.06 | 17.75 | 14.53 | 7.06 | 8.76 | 0.08 | - | 4.00 | - | 8.48 | 0.07 |

METRO CITY IS A PRIORITY **ONE PROJECT**

| | Prince Geo | rge's County P | lanning Departme | ent, M-NCPPC |
|----|--------------------|----------------|----------------------|---------------------|
| | | Environment | tal Planning Section | ın |
| | TREE | CONSERVA | TION PLAN AF | PROVAL |
| | | TCF | 2 -027- 2021 | |
| | Approved by | Date | DRD# | Reason for Revision |
| 00 | Alexander Kirchhof | 9-27-2022 | DSP-20012 | |
| 01 | | | | |
| 02 | | | | |
| 03 | | | | |
| 04 | | | | |
| 05 | | | | |
| 06 | | | | |

DESIGN, INC. - SURVEYOR'S - BELTSVILLE, MD 20705 FAX (301) 937-3507 DEVELOPMENT
- PLANNERS 200 SUITE MILL ROAD -11) 937-3501 CAPITOL | ENGINEERS 4600 POWDER I OFFICE (301

METRO CITY
1,000 ROLLINS AVE.
AT PLEASANT (18TH) ELECTION DISTRICT
PRINCE GEORGE'S COUNTY, MARYLAND

PLAN CONSERVATION I

TREEE REVISIONS

DATE: DEC., 2020 DWN. CHECKED

SCALE: AS SHOWN PROJECT/FILE NO.


SHEET NO. 8 OF 9

AS SHOWN PROJECT/FILE NO. 15-026

SHEET NO. 9 OF 9

MIN 2" STEEL "U" CHANGEL OR 2"12" TIMEER, 6"N LEWSTH 1. LIATS OF DETURBANCE BILL BE SET AS FIRST OF THE REDIES PROCESS
OF AN APPEARS TO:
1. PROF. OF THE SET PROTECTION FROM BE SWED MO FLOORD
1. PROF. OF THE SET PROTECTION FORCE.
1. REDIES THE PROTECTION FORCE.
1. REDIES BETWEEN THE PROTECTION FORCE.
1. REDIES BETWEEN SHOULD BE FREEDED SECURELY TO THE MEMORY PROTE, CROSS BRUNK, AND GROUND. BLAZE ORANGE PLASTIC MESH TREE PROTECTION FENCING FOR WOODLAND PRESERVATION AREAS

TEMPORARY TREE PROTECTION DEVICE (TPD)

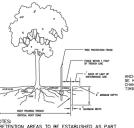


ORDER ME DISK

NOTES:

1. RETENTION AREAS TO BE ESTABLISHED AS PART
OF THE FOREST CONSERVATION PLAN REVIEW
PROCESS.

2. BOUNDAMES OF RETENTION AREAS SHOULD BE
STAKED, FLAGGED AND/OR FENCED PRIOR TO
TRENCHING.

3. EXACT LOCATION OF TRENCH SHOULD BE
INFINITIED.

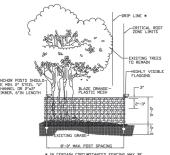

■ IN CERTAIN CIRCUMSTANCES FENCING MAY BE PERMITTED TO BE LOCATED AT THE DRIPLINE.

TRENCHING.

TEACH LOCATION OF TRENCH SHOULD BE
JOENTHIED.

NOTES:

NOT

4"X 4"X 8' PRESSURE TREATED POST WOODLAND PRESERVATION AREA SPECIMEN TREE DO HOT REMOVE MACHINERY, DUMPING MATERIAL, STORAGE OR SITE DISTURBANCE PROHIBITED MACHINERY, DUMPING MATERIAL STORAGE OR SITE DISTURBANCE PROHIBITED TREES FOR YOUR FUTURE 2'-0" 2'-0" MIN. DEPTH 18" MIN. DEPTH 18" SYMBOL: SYMBOL:

GENERAL NOTE: SIGNS FOR PRESERVATION AREAS MAY BE REMOVED AFTER USE & OCCUPANCY PERMIT HAS BEEN ISSUED.

SIGNAGE

- NOTES:

 1. ATTACHMENT OF SIGNS TO TREES IS PROHIBITED.

 2. SIGNS SHOULD BE PROPERLY MAINTAINED.

 3. AVOID INJURY TO ROOTS WHEN PLACING POSTS FOR THE SIGNS.

 4. SIGNS SHOULD BE POSTED TO BE VISIBLE TO ALL CONSTRUCTION
- PERSONNEL FROM ALL DIRECTIONS.

 5. SIGNS SHOULD BE INSTALLED AT THE SAME TIME AS TREE.
- 5. SIGNS SHOULD BE INSTALLED AT THE SAME TIME AS TREE PROTECTION DEVICE:

 6. SIGNE SHOWS APPOINTED YEARY SO FEET ALONG FENCING.

 7. SIGNE SHOWS APPOINTED AND PLACE IMMEDIATELY FOLLOWING STAKE OUT OF LOD, AND REMAIN IN PLACE IN PERPETUITY.

 8. SIGNS MAY ALSO BE MOUNTED ON TEMPORARY OR PERMANENT TREE PROTECTION FENCING.

THE MARYLAND-NATIONAL CAPITAL PARK AND PLANNING COMMISSION

APPLICATION NAME: METRO CITY

APPLICATION NO.: DSP-20012

TCP NO.: TCP2-027-2021 SIGNATURE APPROVAL OF THIS PLAN IS IN ACCORDANCE WITH PGCPB RESOLUTION NO. 2022-11 DATED FEBRUARY 10, 2022.

SIGNATURE APPROVAL DATE:

Fothergill,


Fothergill, Anne Date: 2022.10.13 12:31:51 -04'00'

AUTHORIZED SIGNATURE

APPLICANT

METRO CITY LLC 10701 LADY SLIPPER TERRACE ROCKVILLE, MD. 20852 PHONE® 301-467-5536 E-MAIL: AGIDEVCO@VERIZON.NET

MISS UTILITY
FOR LOCATION OF UTILITIES CALL 1-800-257-7777
48 HOURS IN ADVANCE OF ANY WORK IN THE VICINIT

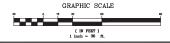

QUALIFIED PROFESSIONAL CERTIFICATION THIS PLAN COMPLIES WITH THE CURRENT REQUIREMENTS OF SUBTITLE 25 AND THE WOOD LAND WILDLIFE

POWDER MILL ROAD - SUITE 200 - BELTSVILLE, MD 20705 PHONE (301) 937-3501, EMAIL:PEREZ@CDDI.NET

| | | Environment | tal Planning Sectio | n |
|------|---|-----------------------------------|--------------------------------------|--|
| | TREE | CONSERVA | TION PLAN AP | PROVAL |
| | | TCF | 2 -027- 2021 | |
| | Approved by | Date | DRD# | Reason for Revision |
| 00 | Alexander Kirchles | 9-27-2022 | DSP-20012 | |
| 01 | | | | |
| 02 | | | | |
| 03 | | | | |
| 04 | | | | |
| 05 | | | | |
| 06 | | | | |
| requ | irements on-site hav nent recorded in Prin | e been placed i ice George's C | n woodland and w ounty Land Recor | nt of woodland conservation ildlife habitat conservation ds at Liber 47970, Folio 30 e recorded easement. |