









CV, INC.
 1395 PICCARD DRIVE, SUITE 370
 ROCKVILLE, MARYLAND 20850
 PHONE: (301) 637-2510
 FAX: (240) 252-5612
 CONTACT: CHINMAY VYAS, P.E.
 EMAIL: CVYAS@CVINC.COM

QUALIFIED PROFESSIONAL CERTIFICATION

Signed: John P. Markovich Date: 6/9/13

John P. Markovich
JM Forestry Services, LLC
11552 Timberbrook Drive
Waldorf, MD 20601
Phone: 301-645-4977
E-mail:
jpmarkovich@comcast.net



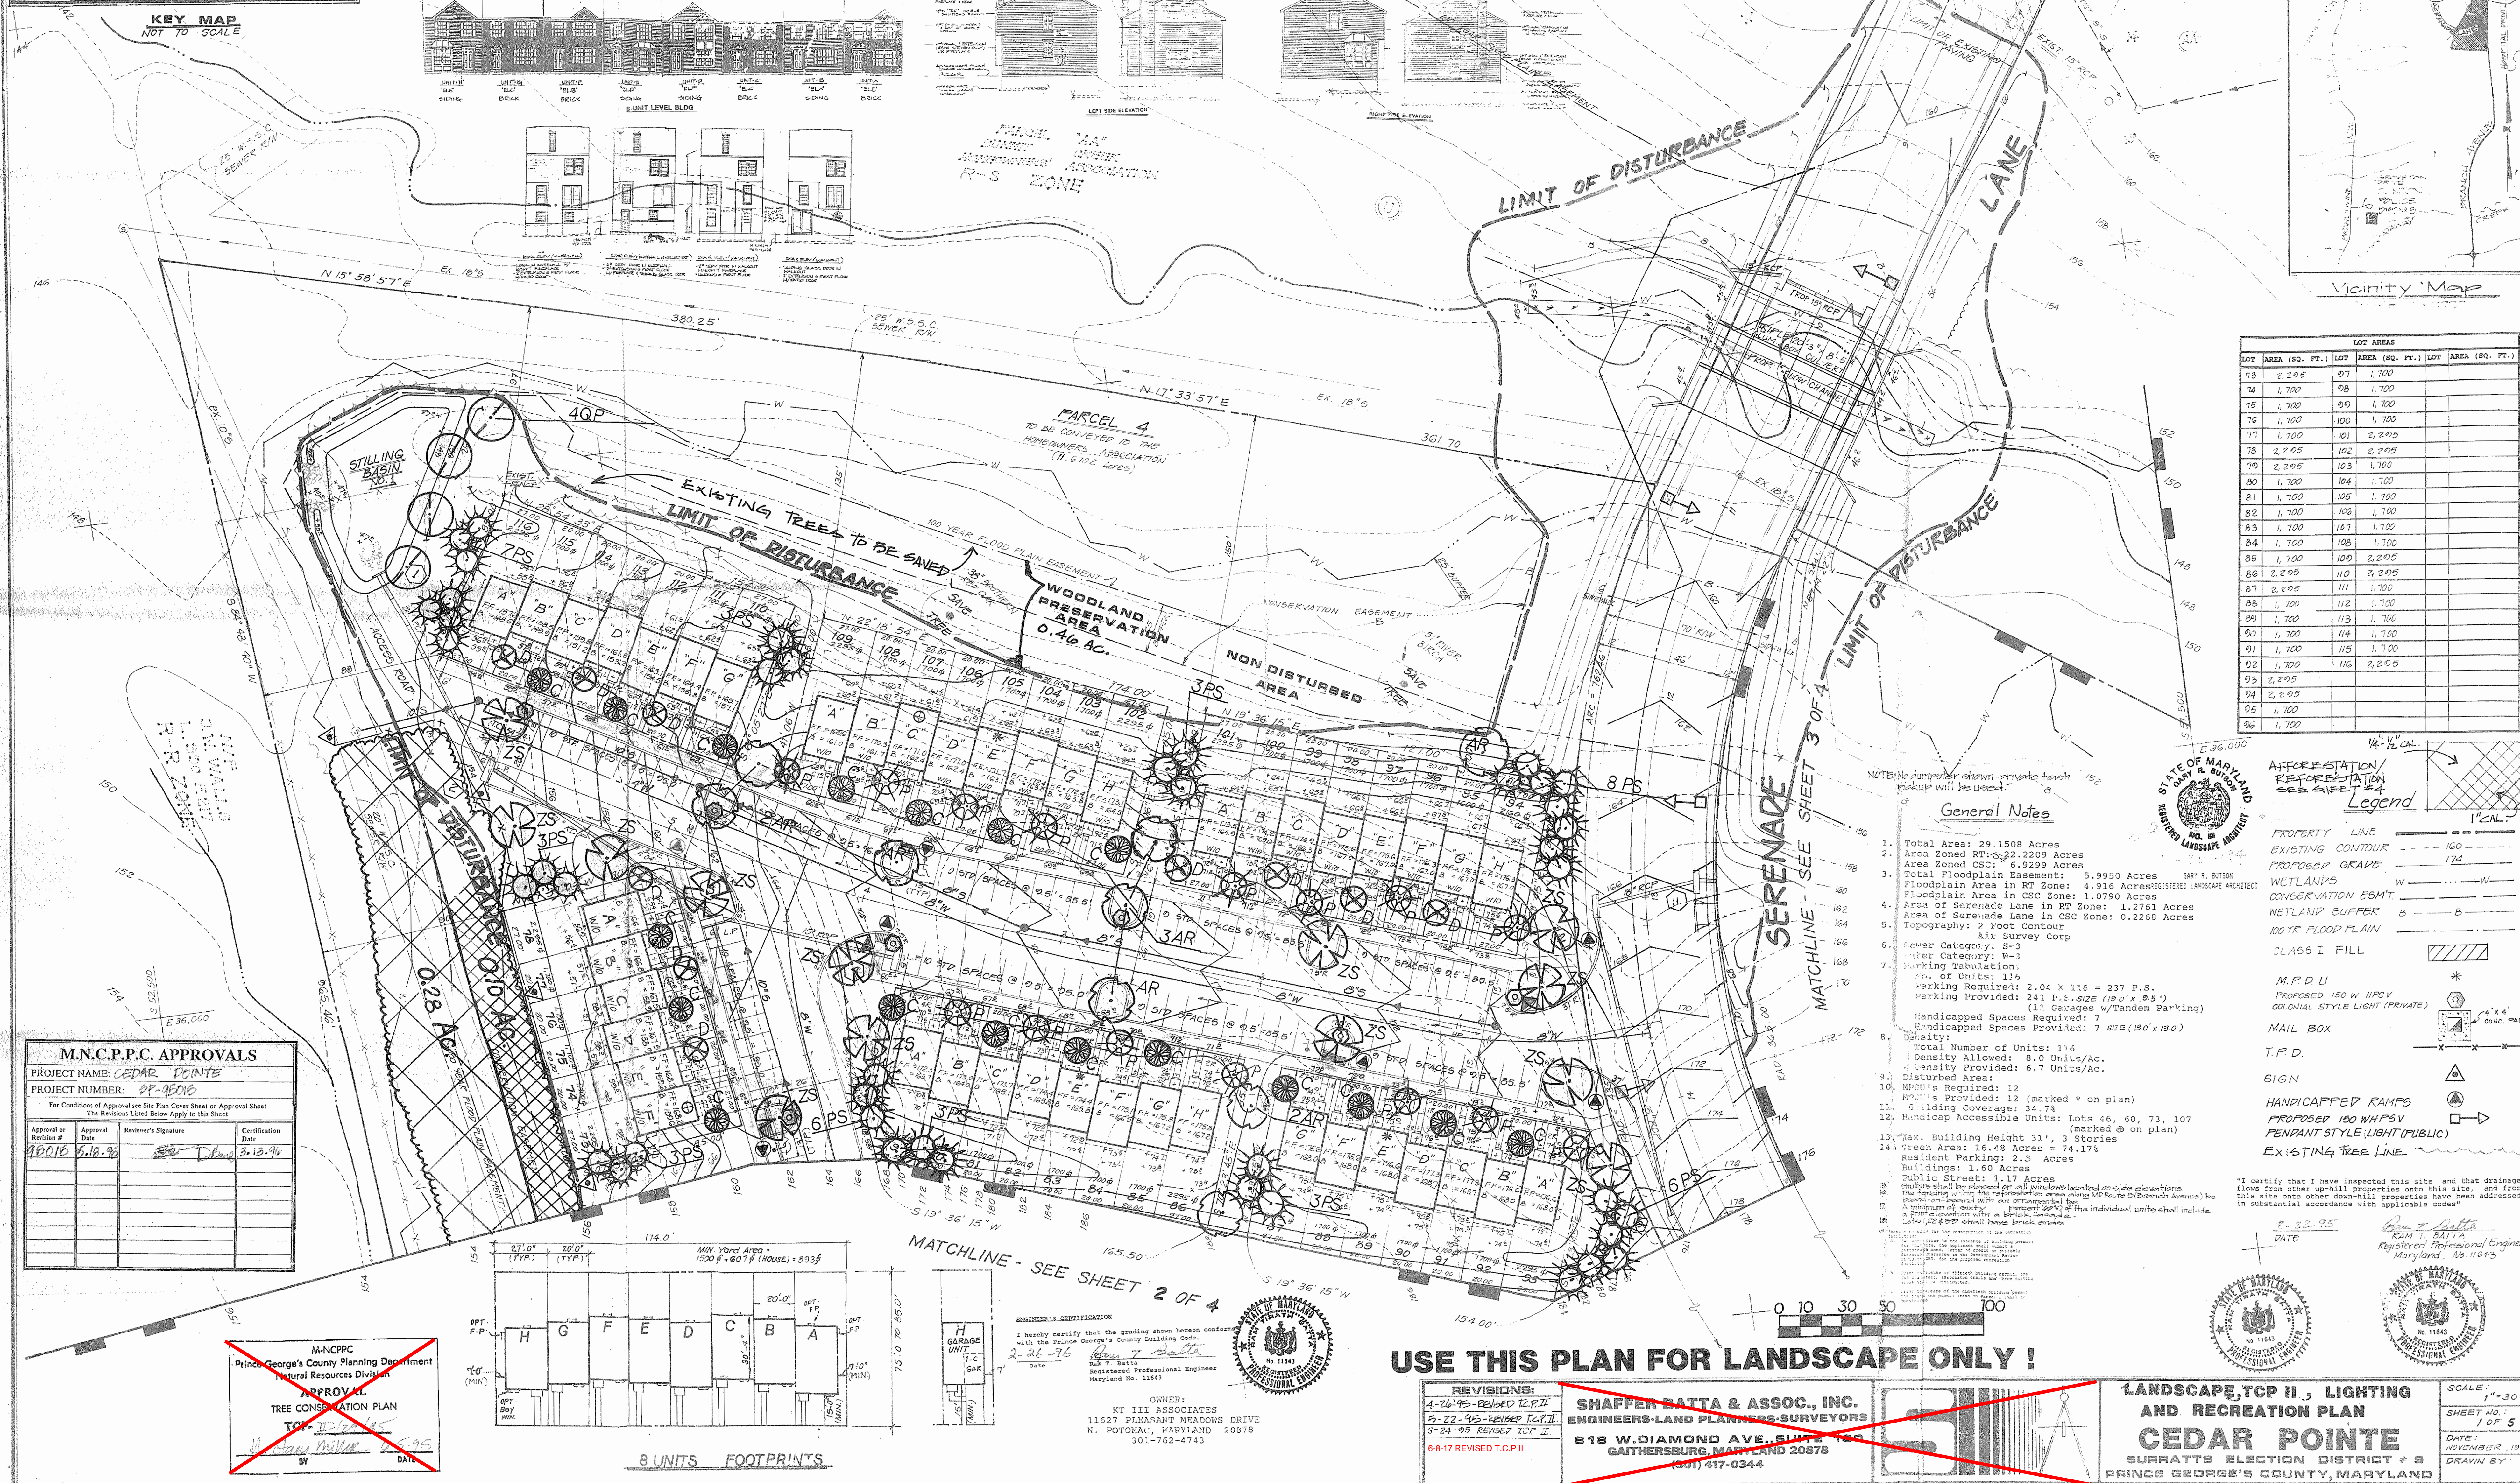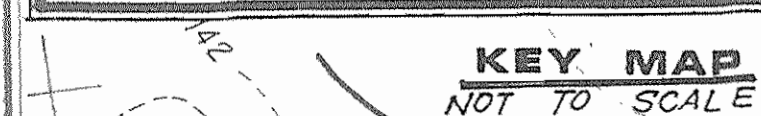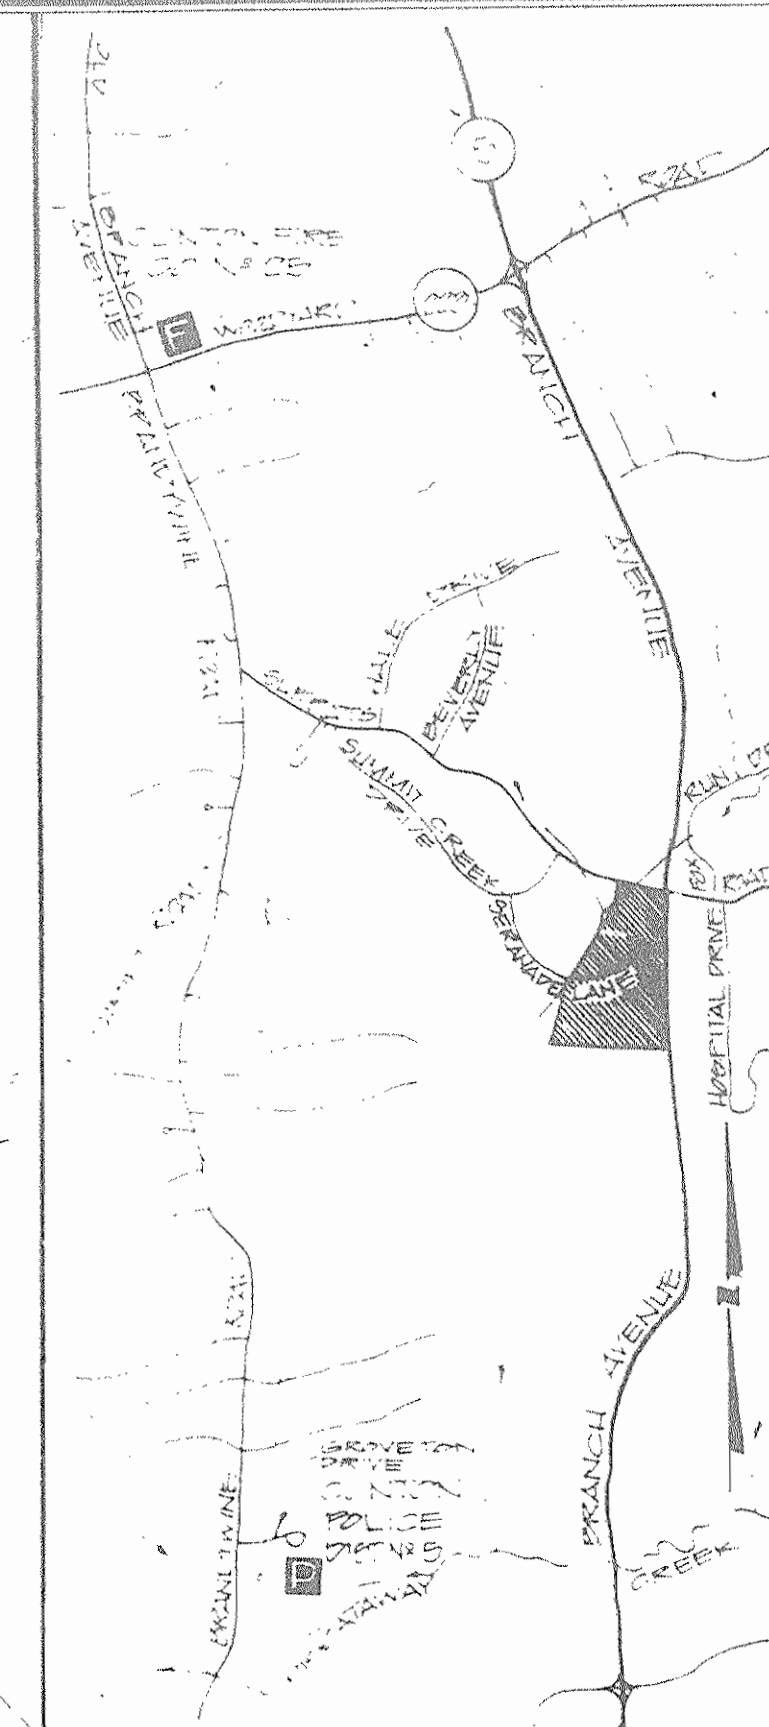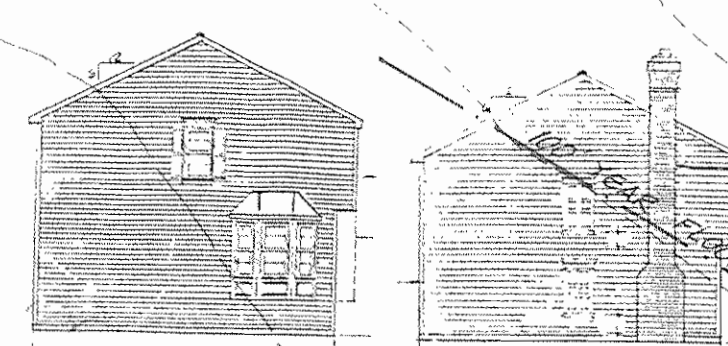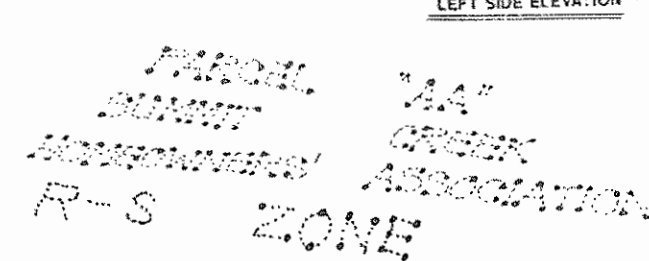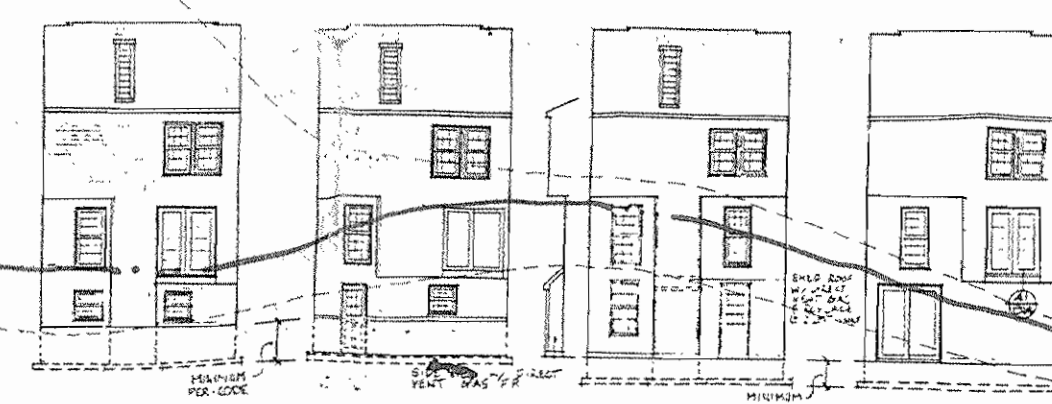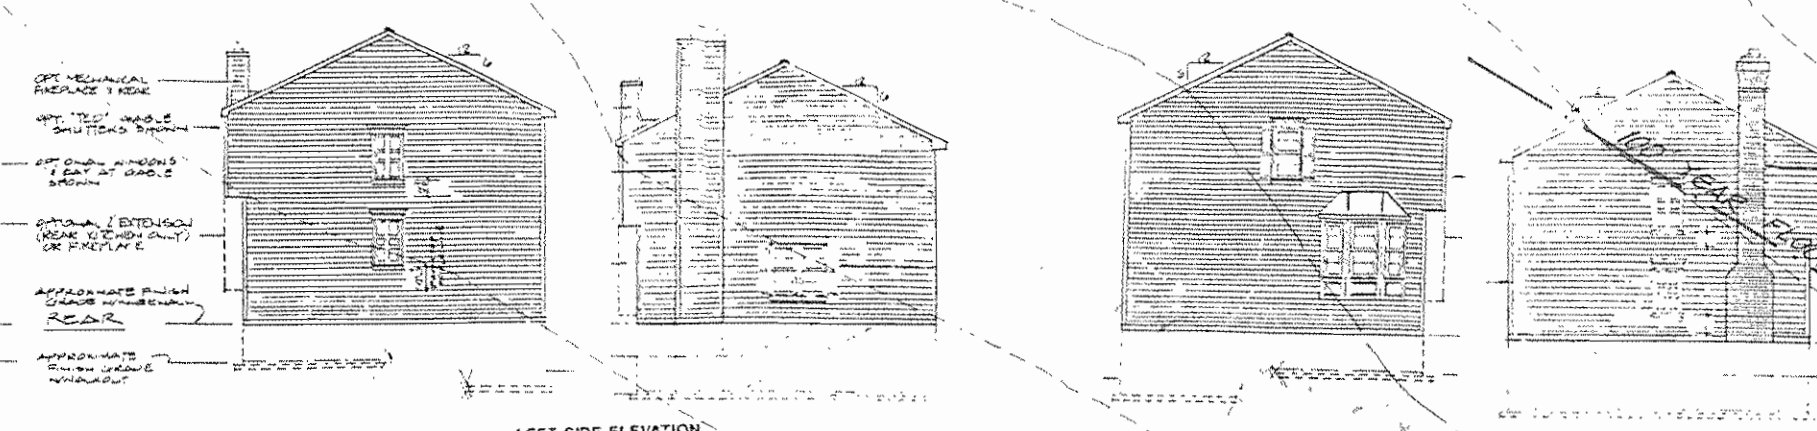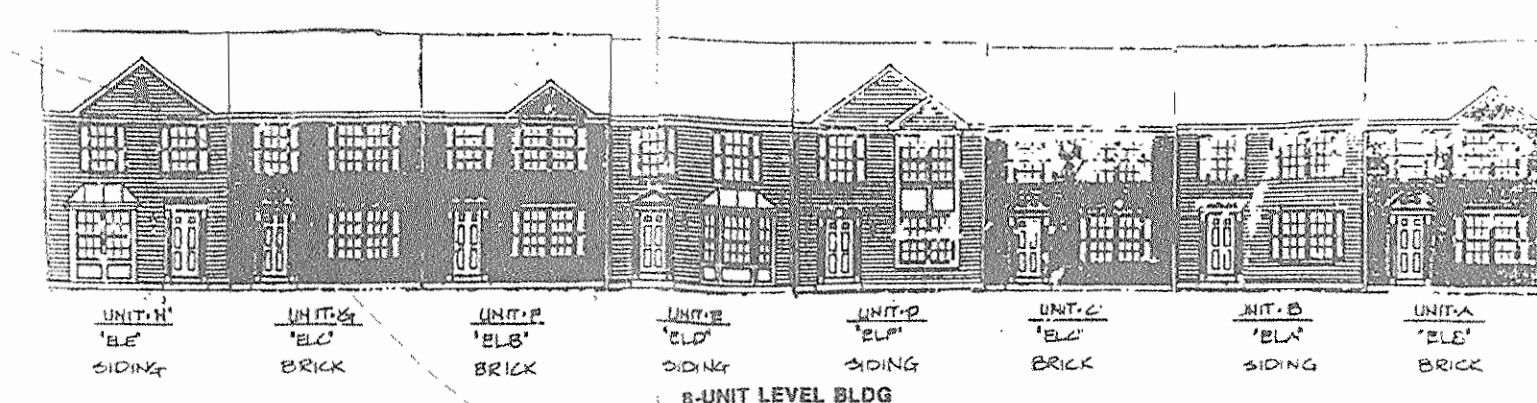

LOT AREAS					
LOT	AREA (SQ. FT.)	LOT	AREA (SQ. FT.)	LOT	AREA (SQ. FT.)
13	2,295	97	1,700		
14	1,700	98	1,700		
15	1,700	99	1,700		
16	1,700	100	1,700		
17	1,700	01	2,295		
18	2,295	02	2,295		
19	2,295	03	1,700		
20	1,700	04	1,700		
21	1,700	05	1,700		
22	1,700	06	1,700		
23	1,700	07	1,700		
24	1,700	08	1,700		
25	1,700	09	2,295		
26	2,295	10	2,295		
27	2,295	11	1,700		
28	1,700	12	1,700		
29	1,700	13	1,700		
30	1,700	14	1,700		
31	1,700	15	1,700		
32	1,700	16	2,295		
33	2,295				
34	2,295				
35	1,700				
36	1,700				

NOTE: No dumpster shown - private trash pickup will be used. 8

1. Total Area: 29.1508 Acres
2. Area Zoned RT-2: 22.2209 Acres
3. Area Zoned CSC: 6.9299 Acres
4. Total Floodplain Area: 5.9950 Acres
5. Floodplain Area in Zone C: 4.916 Acres
6. Floodplain Area in CSC Zone: 1.0790 Acres
7. Area of Serenade Lane in RT Zone: 1.2761 Acres
8. Area of Serenade Lane in CSC Zone: 0.2268 Acres
9. Topography: ? Root Contour
10. Air Survey Corp.
11. Power Category: S-3
12. Water Category:
13. Parking Tabulation:
14. No. of Units: 116
15. Parking Required: 2.04 x 116 = 237 P.S.
16. Parking Provided: 141 x .85 (190' x 8.5'
 (11 Garages w/Tandem Parking)
17. Handicapped Spaces Required: 7
18. Handicapped Spaces Provided: 7 SIZE (190' x 180')
19. Density:
20. Total Number of Units: 116
21. Density Allowed: 8.0 Units/Ac.
22. Density Provided: 6.7 Units/Ac.
23. Disturbed Area:
24. MDCU's Required: 12
25. MDCU's Provided: 12 (marked * on plan)
26. Building Coverage:
27. Handicap Accessible Units: Lots 46, 60, 73, 107
 (marked @ on plan)
28. Max. Building Height 31', 3 Stories
29. Gross Area: 16.48 Acres
30. Resident Parking: 2.3 Acres
31. Buildings: 1.60 Acres
32. Public Street: 1.17 Acres
33. The following are placed on windows located on outside elevations
The Tearing & Winding Information area along Mid Route Dr Branches Areas
Impact Considered with a Second Level
A minimum of twenty percent (20%) of the individual units shall include

AFFORESTATION/
 REFORESTATION
 SEE SHEET #4
Legend

PROPERTY LINE _____

EXISTING CONTOUR _____ 170 _____


PROPOSED GRADE _____ 174 _____

WETLANDS _____ W _____ W _____

CONSERVATION ESMT _____

WETLAND BUFFER _____ B _____ B _____


100' FLOOD PLAIN _____

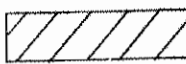CLASS I FILL 

M.P.D.U.

PROPOSED 150 W HPSV


COLONIAL STYLE LIGHT (PRIVATE)

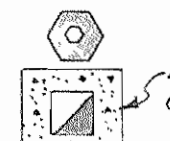

MAIL BOX

T.P.D.


SIGN



HANDICAPPED RAMPS

PROPOSED 150 W HPSV

PENDANT STYLE LIGHT (PUBLIC)



EXISTING TORE LINE _____

"I certify that I have inspected this site and that drainage flows from other up-hill properties onto this site, and from this site onto other down-hill properties have been addressed in substantial accordance with applicable codes"


USE THIS PLAN FOR LANDSCAPE ONLY !

REVISIONS
4-26-95-REVISED T.C.
5-22-95-REVISED T.C.
5-24-95 REVISED T.C.
6-8-17 REVISED T.C.P II

~~SHAFER BATT & ASSOC., INC.
ENGINEERS-LAND PLANNERS-SURVEYORS
818 W. DIAMOND AVE., SUITE 100
GAITHERSBURG, MARYLAND 20878
(301) 417-0344~~

**LANDSCAPE, TCP II., LIGHTING
AND RECREATION PLAN
CEDAR POINTE
SURREATTS ELECTION DISTRICT # 9
PRINCE GEORGE'S COUNTY, MARYLAND**

SCALE:	1"=30'
SHEET NO.:	1 OF 5
DATE:	NOVEMBER, 19
DRAWN BY:	

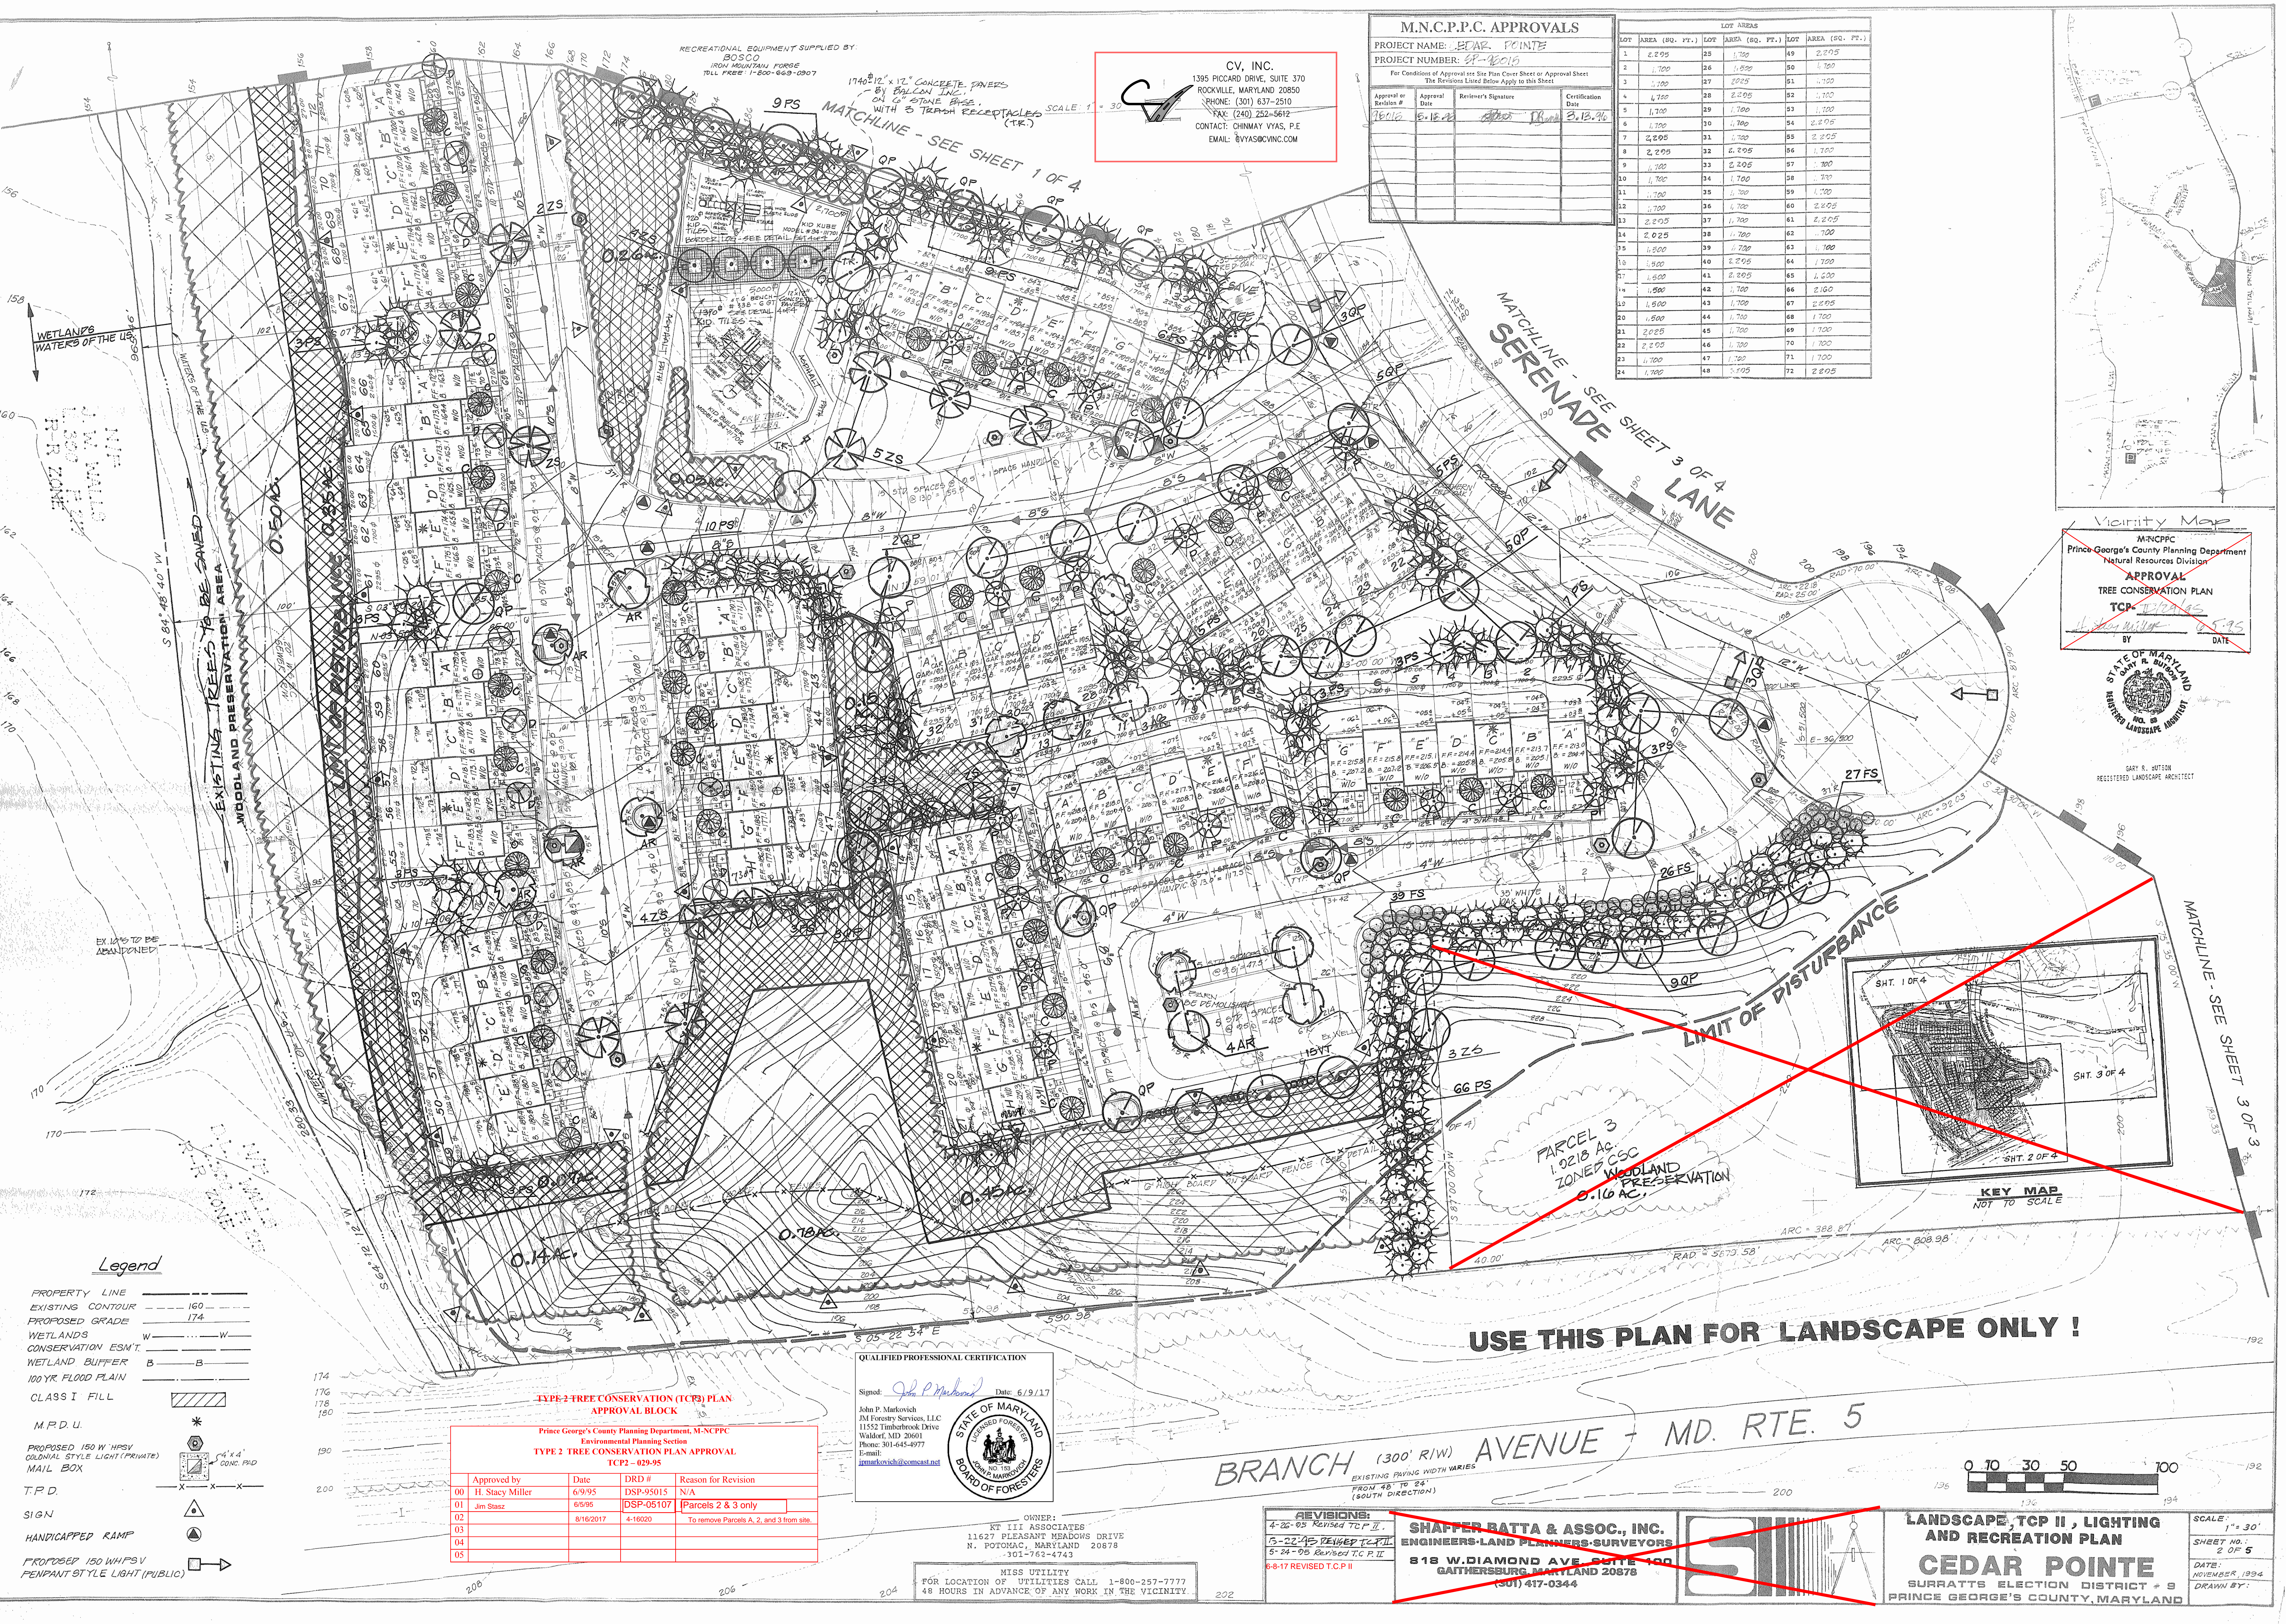


M.N.C.P.C. APPROVALS			
PROJECT NAME: CEDAR POINTE			
PROJECT NUMBER: 2010-0010			
For Conditions of Approval see Site Plan Cover Sheet or Approval Sheet			
The Revisions Listed Below Apply to this Sheet			
Approval or Revision #	Approval Date	Reviewer's Signature	Certification Date
1	6/18/10	[Signature]	6/18/10
2	6/18/10	[Signature]	6/18/10
3	6/18/10	[Signature]	6/18/10
4	6/18/10	[Signature]	6/18/10
5	6/18/10	[Signature]	6/18/10
6	6/18/10	[Signature]	6/18/10
7	6/18/10	[Signature]	6/18/10
8	6/18/10	[Signature]	6/18/10
9	6/18/10	[Signature]	6/18/10
10	6/18/10	[Signature]	6/18/10
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21	6/18/10	[Signature]	6/18/10
22	6/18/10	[Signature]	6/18/10
23	6/18/10	[Signature]	6/18/10
24	6/18/10	[Signature]	6/18/10

Vicinity Map
M.N.C.P.C.
Prince George's County Planning Department
Natural Resources Division
APPROVAL
TREE CONSERVATION PLAN
TCP-2010-0010
BY: [Signature] DATE: 6/18/10




GARY R. HUTTON
REGISTERED LANDSCAPE ARCHITECT

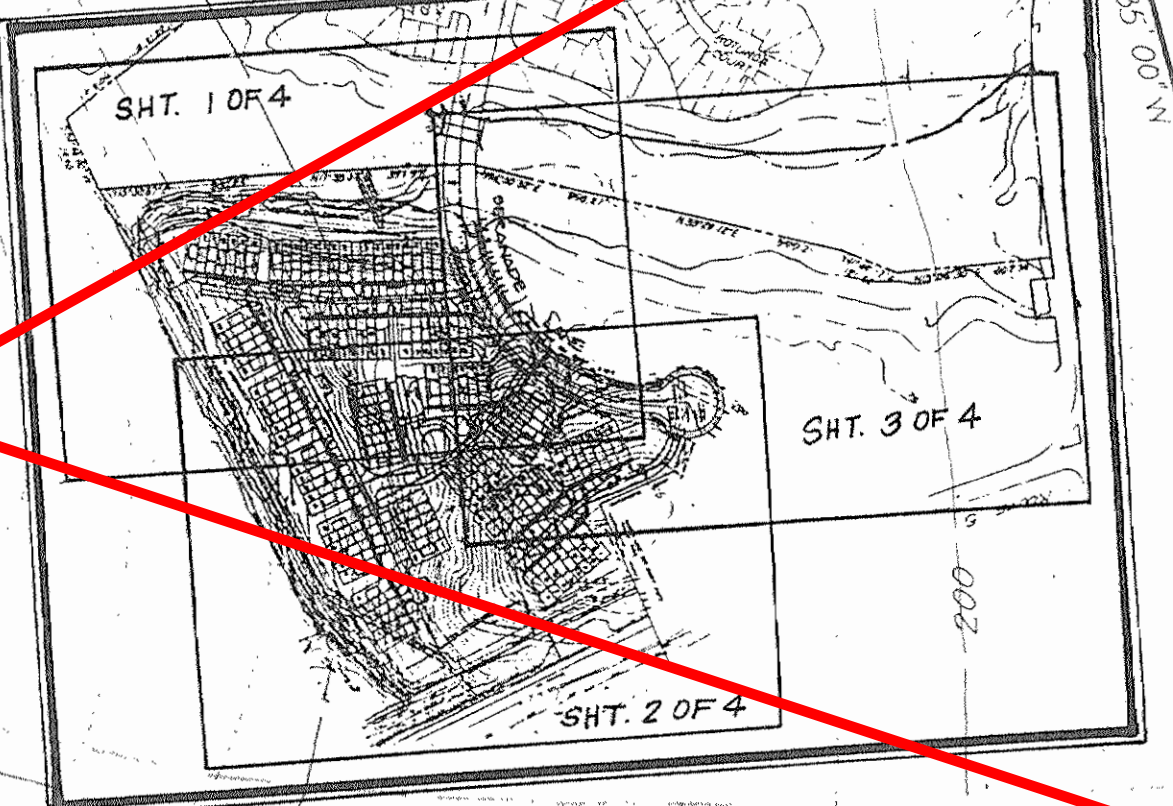

USE THIS PLAN FOR LANDSCAPE ONLY !

BRANCH (300' R/W) AVENUE + MD. RTE. 5
EXISTING PAVING WIDTH VARIES FROM 48' TO 24' (SOUTH DIRECTION)

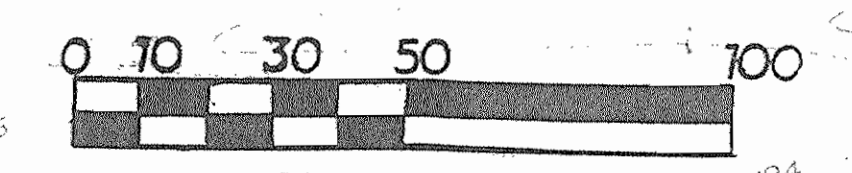

TYPE 2 TREE CONSERVATION (TCP) PLAN APPROVAL BLOCK			
Prince George's County Planning Department, M.N.C.P.C. Environmental Planning Section TYPE 2 TREE CONSERVATION PLAN APPROVAL TCP-2 - 029-95			
Approved by	Date	DRD #	Reason for Revision
00 H. Stacy Miller	6/9/95	DSP-95015	N/A
01 Jim Stasz	6/5/95	DSP-05107	Parcels 2 & 3 only
02	8/16/2017	4-16020	To remove Parcels A, 2, and 3 from site.
03			
04			
05			

QUALIFIED PROFESSIONAL CERTIFICATION
Signed: [Signature] Date: 6/9/17
John P. Markovich
JMI Forestry Services, LLC
11552 Timberbrook Drive
Waldorf, MD 20601
Phone: 301-645-4977
E-mail: jmarkovich@comcast.net

OWNER:
RT 112 ASSOCIATES
11627 PLEASANT MEADOWS DRIVE
N. POTOMAC, MARYLAND 20878
301-762-6743
MISS UTILITY
FOR LOCATION OF UTILITIES CALL 1-800-257-7777
48 HOURS IN ADVANCE OF ANY WORK IN THE VICINITY.


REVISIONS:
4-26-05 REVISED TCP II.
5-22-05 REVISED TCP II.
5-24-05 REVISED TCP II.
6-17-05 REVISED TCP II.

SHAFER BATT & ASSOC., INC.
ENGINEERS-LAND PLANNERS-SURVEYORS
818 W. DIAMOND AVE. SUITE 100
GAITHERSBURG, MARYLAND 20878
(301) 417-0344

LANDSCAPE, TCP II, LIGHTING
AND RECREATION PLAN
CEDAR POINTE
SURRETT'S ELECTION DISTRICT # 9
PRINCE GEORGE'S COUNTY, MARYLAND

SCALE: 1" = 30'
SHEET NO. 2 OF 5
DATE: NOVEMBER, 1994
DRAWN BY:

Prince George's County Planning Department, M-NCPPC Environmental Planning Section TYPE 2 TREE CONSERVATION PLAN APPROVAL TC2 - 029-95				
	Approved by	Date	DRD #	Reason for Revision
00	H. Stacy Miller	6/9/95	DSP-95015	N/A
01	Jim Stasz	6/9/95	DSP-05107	For Parcels 2 & 3 only
02		8/16/2017	4-16020	To remove Parcels A, 2, and 3 from site
03				
04				
05				



CV, INC.
1395 PICCARD DRIVE, SUITE 370
ROCKVILLE, MARYLAND 20850
PHONE: (301) 637-2510
FAX: (240) 252-5612
CONTACT: CHINMAY VYAS, P.E.
EMAIL: CVYAS@CVINC.COM


QUALIFIED PROFESSIONAL CERTIFICATION

Signed: John P. Markovich Date: 6/9/17


John P. Markovich
JM Forestry Services, LLC
11552 Timberbrook Drive
Waldorf, MD 20601
Phone: 301-645-4977
E-mail:
jmarkovich@comcast.net

STATE OF MARYLAND
LICENSED FORESTER

JOHN P. MARKOVICH
BOARD OF FORESTERS
NO. 153

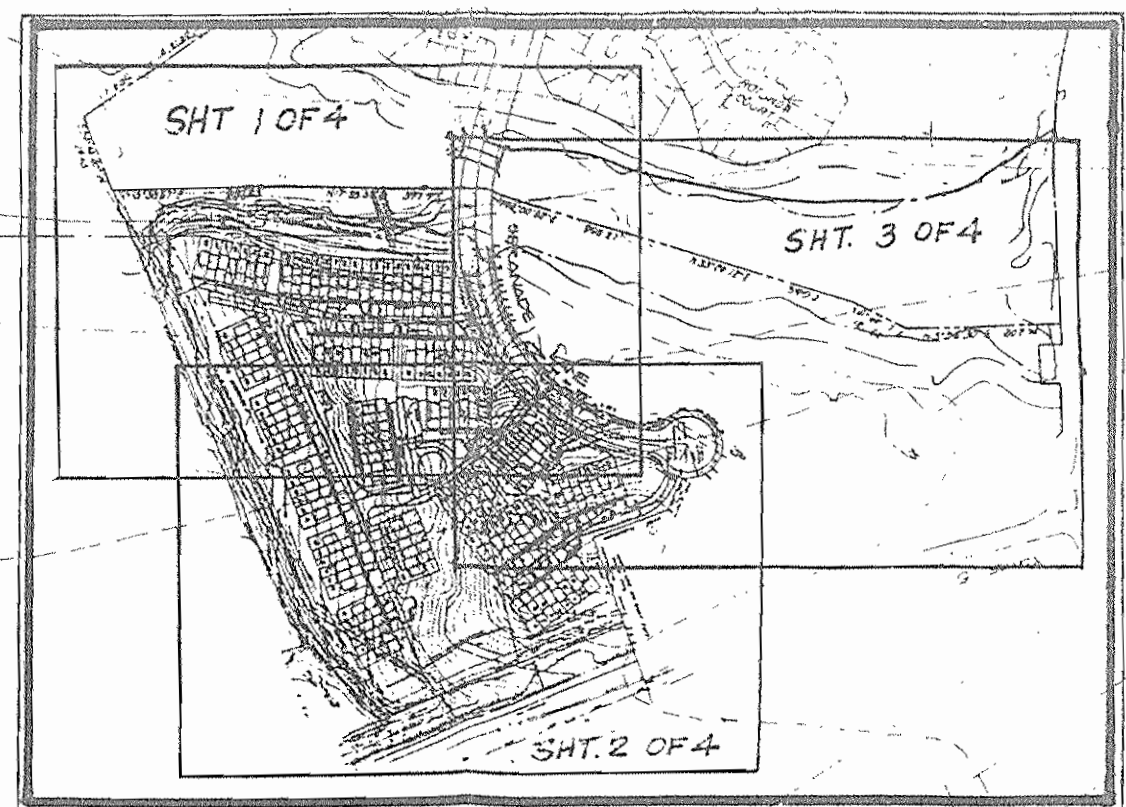[illegible]

KEY MAP
NOT TO SCALE

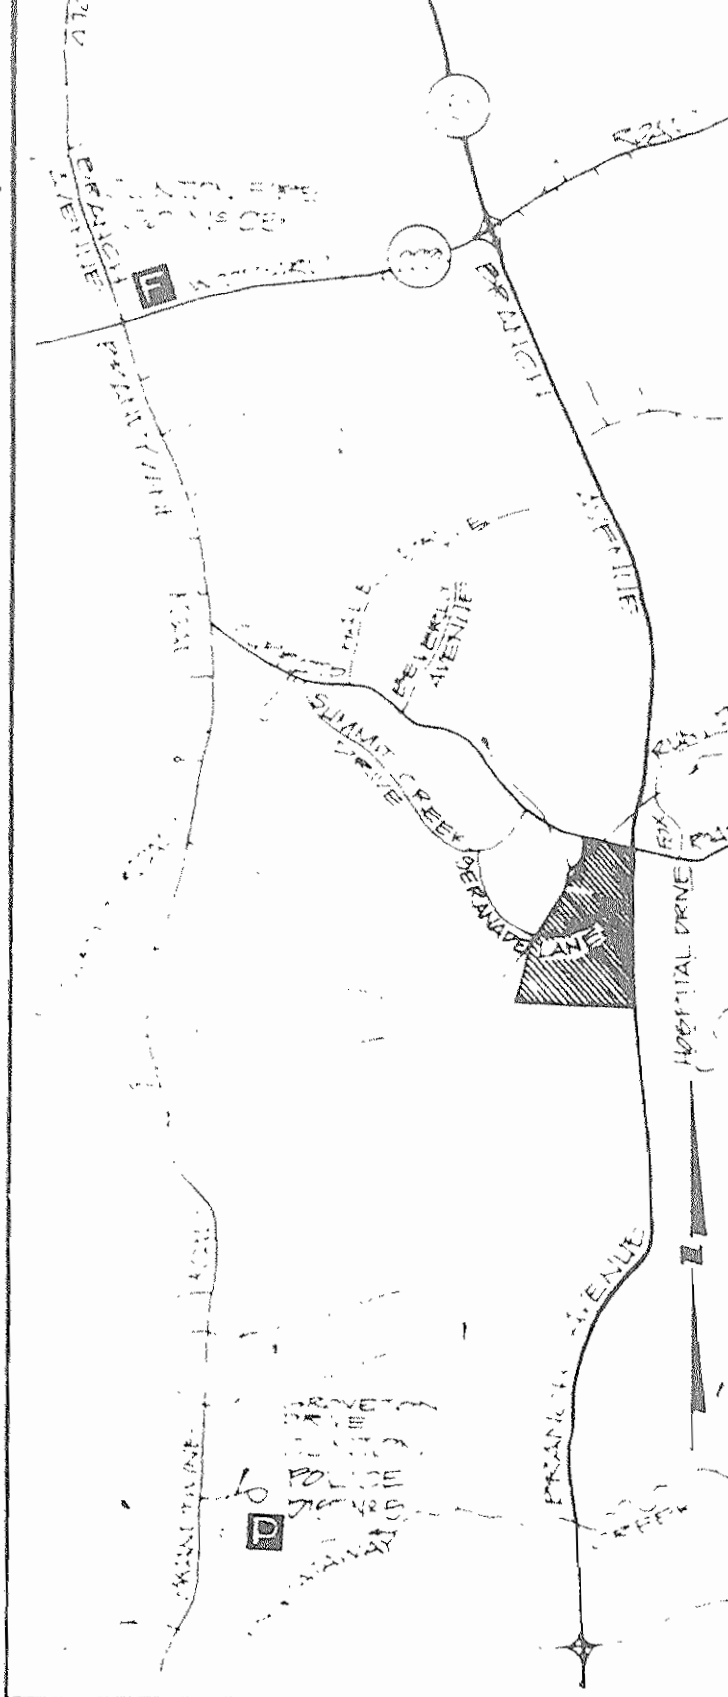

Vicinity Map

SERENADE

MATCH LINE - SEE SHEET 2 OF 4
(70' R/W)

LANE

Woodland Conservation Worksheet

Non-Governmental Projects

Zone: RT Owner: K.T. III
Gross Tract: 23.22 Address: 11607 PLEASANT MEADOW
Floodplain: 5.09 N. PETERBORO, MD. 20878
Previously - Phone: 301-462-1743
Dedicated Land- - Tax map: 12B E2
Net Tract: 17.13 Permit #: -
Subdivision/Block/Lot: CEDAR POINTE 1-110 BLK A

Woodland and Conservation Calculations:

	Net Tract (acres)	Floodplain (acres)
Existing Woodland	a. 2.79	b. 4.41
WCT ($\frac{2.79}{2.79} \times \text{Net Tract}^2$)	c. 3.16	
Smaller of a. or b.	d. 2.79	
Woodland above WCT (a - b); 0 if < 0	e. 0.00	
Woodland Cleared	f. 0.00	g. 0.40
Smaller of d. or e.	f. 0.00	
Cleared below WCT (e - f); 0 if < 0	h. 0.00	
Replacement (f x 0.25)	i. 0.00	
Afforestation (g x 2.0)	j. 0.80	
(net tract x 2) - a.; or (net tract x .15) - a.; 0 if < 0	k. 0.00	
Woodland and Conservation Required: (c+h+i-j-k) - m.	0.75	

Woodland Conservation Provided: (acres) _____
 Woodland Preservation 2.01
 Reforestation / Replantement 3.24
 Afforestation 2
 Acres approved for fee-in-lieu _____ \$0.70 * 43560 \$ _____
 Off-site Credits _____
 Woodland Conservation Provided _____
 (must equal or exceed item "m" above) 5.25 and \$ _____

Additional woodland retained but not part of any requirements: _____ acres

Plan Certified by: Name GARY R. BUTSON
Address 904 WIND RIVER LN. #105
SALETSBURG, MD. 20878
License LANDSCAPE ARCHITECT

Note: As of 8/16/2017, it was noted that the TCP was previously approved and implemented with an error in this worksheet. There is 0.01 acres of woodland conservation still required to be met onsite or in fee-in-lieu. Any future development on this property will have meet this requirement onsite or in fee-in-lieu..

Woodland Conservation Worksheet

Non-Governmental Projects

Zone: CSC Owner: K.T. III
Gross Tract: 6.93 Address: 11627 BLOODHUNT HOLLOW
Floodplain: 1.10 N. POTOMAC, MD. 20877
Previously: - Phone: 301-772-4943
Dedicated Land: - Tax map: 125 E-2
Net Tract: 5.83 Permit #: -
Subdivision/Block/Lot: CEPARE PRINTE

Woodland Conservation Calculations:

	Net Tract (acres)	Floodplain (acres)
Existing Woodland	2.66	0.64
WCT (-1.16) x Net tract (-)	0.66	
Smaller of a, or b.	0.66	
Woodland above WCT (a - b): 0 if < 0	0.66	
Woodland Cleared	0.66	0
Smaller of d, or e	0.66	
Clearing below WCT (e - f): 0 if < 0	0.66	
Replacement (f x 0.25)	0.16	
(g x 2.0)	0.16	
Afforestation (if applicable)		
(net tract x 2) - a, or 0	0.21	
(net tract x 15 a) - f, if < 0	0.21	
Woodland Conservation Required	0.21	0.91

Woodland Conservation Provided: (acres) 0.70
 Woodland Preservation 0.21
 Reforestation / Replacement 0.21
 Afforestation _____
 Area approved for fee-in-lieu \$0.30 x 43560 \$ _____
 Off-site Credits _____
 Woodland Conservation Provided _____
 (must equal or exceed item "m" above) 0.91 and \$ _____

Additional woodland retained but not part of any requirements: _____ acres

Plan Certified by: Name EARN R. BUTSON
Address 904 WIND RIVER LN. #105
GAITHERSBURG MD. 20878
License LANDSCAPE ARCHITECT

STATE OF MARYLAND
GARY R. BUTSON
REGISTERED LANDSCAPE ARCHITECT
NO. 68
GARY R. BUTSON
REGISTERED LANDSCAPE ARCHITECT

PARCEL 3
83,715 sq. ft. or 1.9218 AC
— ZONED CSD

APPROVAL
TREE CONSERVATION PLAN
TCF
DATE

REVISIONS:
4-26-95 Revised T.C.P.
5-22-95 REVISED T.C.P.
6-8-17 REVISED T.C.P II

SHAFFER BATTA & ASSOC., INC.
ENGINEERS-LAND PLANNERS-SURVEYORS
818 W. DIAMOND AVE., SUITE 100
GAITHERSBURG, MARYLAND 20878
(301) 417-0344

**LANDSCAPE, TCP II , LIGHTING
AND RECREATION PLAN
CEDAR POINTE
SURREATTS ELECTION DISTRICT # 9
PRINCE GEORGE'S COUNTY, MARYLAND**

SCALE:
1" = 30'

SHEET NO.:
3 OF 5

DATE:
NOV. 18 1934

DRAWN BY:
D.G. LEANO

A. Materials

- (1) Plants shall be nursery grown in accordance with good horticultural practice, and grown under climatic conditions similar to those in the locality of the project. They shall have been kept pruned, preferably within the last year.
- (2) They shall be sound, healthy and vigorous, well branched and densely foliated when in leaf. They shall be free of disease, pests, eggs or larvae, and shall have a healthy, developed root system.
- (3) Plants shall not be pruned before delivery. Trees with a damaged or crooked leader or multiple leaders, abrasions on the bark, sunscald, disfiguring knots or fresh cuts over 1/2" will be rejected.

No change in quantity, size, kind or quality of plant specified will be permitted without the approval of the landscape architect.



- (1) Topsoil shall be fertile, friable and typical of the soil in place. It shall be free from stones, sticks, stumps and shall not be delivered in a frozen or muddy condition.
- (2) Planting soil (backfill mix) shall be five-parts topsoil and one-part wet loam peat moss.
- (3) Staking materials: Cows wire shall be pliable 1/8" gauge galvanized twisted Low-carbon steel wire. Minimum length of twist 2' rather than 3' as in diameter, stakes shall conform to the detail on this sheet.
- (4) Wrapping material shall be a standard manufactured tree wrapping paper with crinkled surface and fastened by an approved method.

B. Applicable Specifications and Standards.

- (1) "Standard Plant Names," latest edition American Joint Committee on Horticultural Nomenclature.
- (2) "American Standard for Nursery Stock," latest edition, American Association of Nurserymen.

C. Digging and Handling of Plant Materials

- (1) Immediately before digging, spray all evergreen or deciduous plants in full leaf with anti-desiccant.

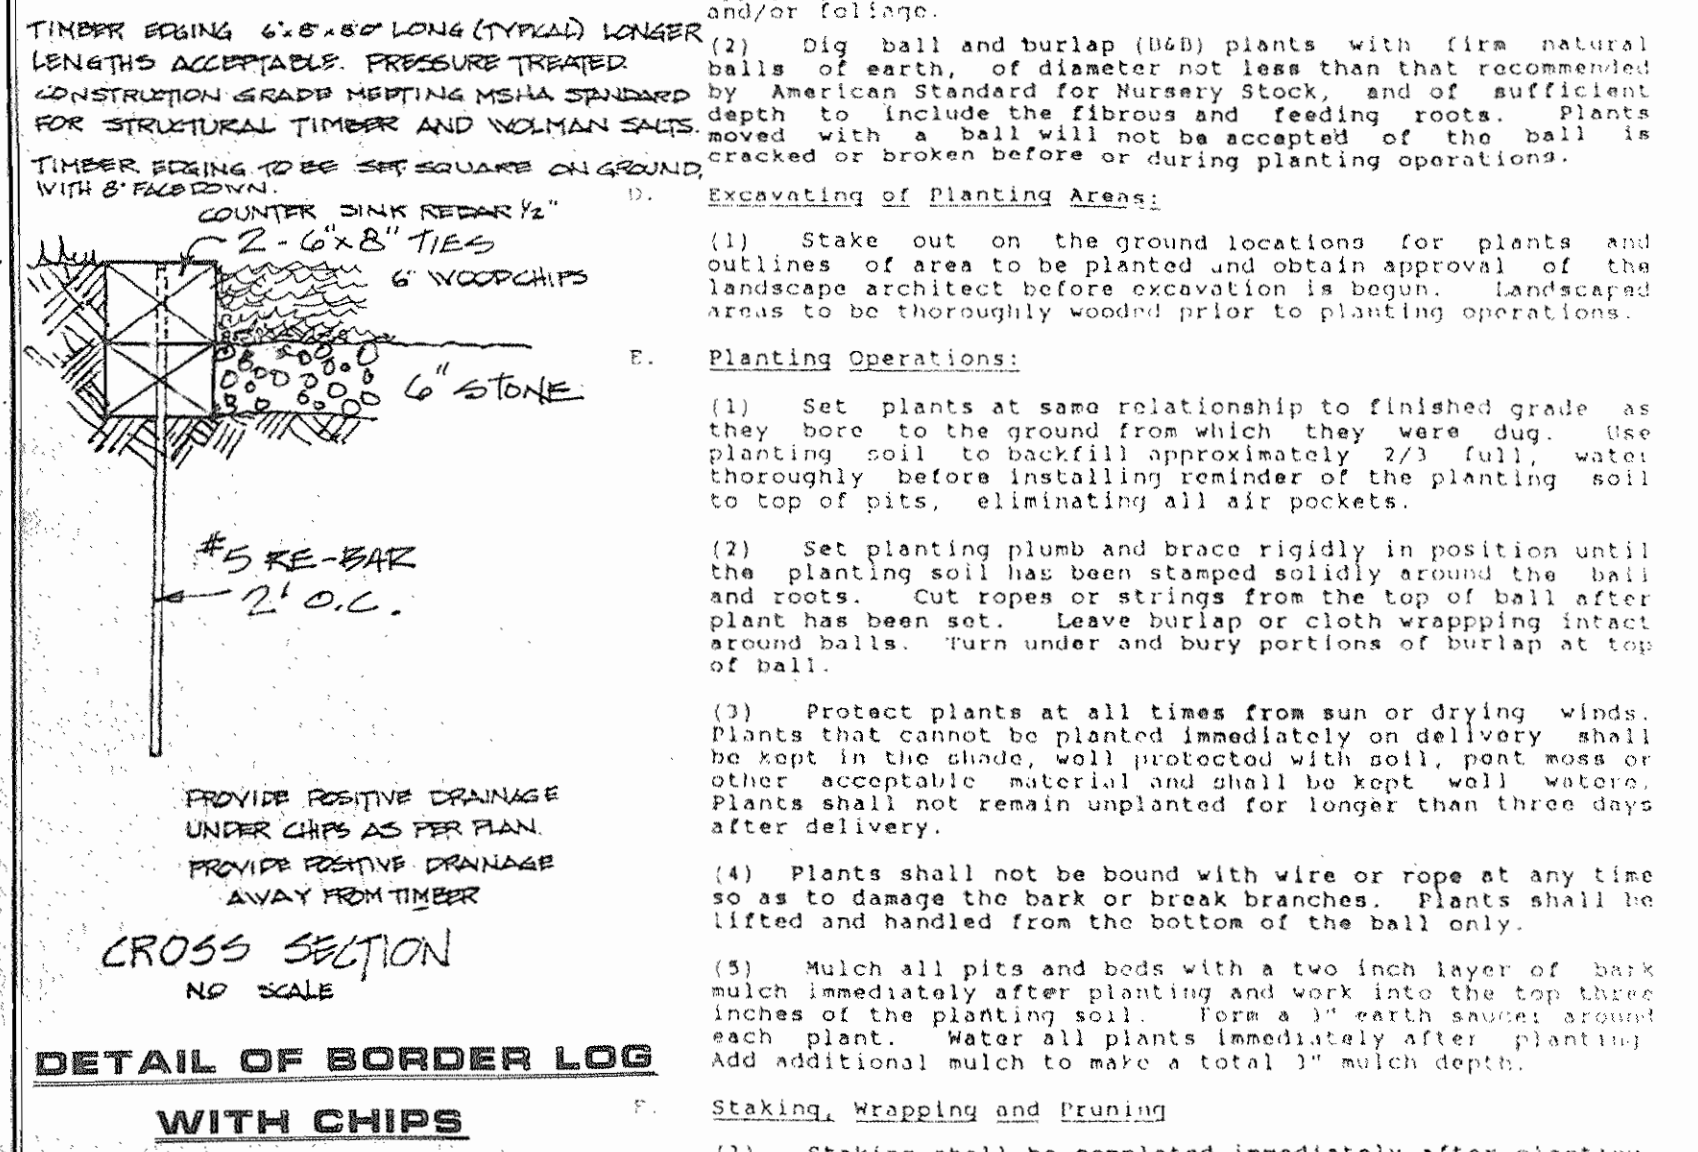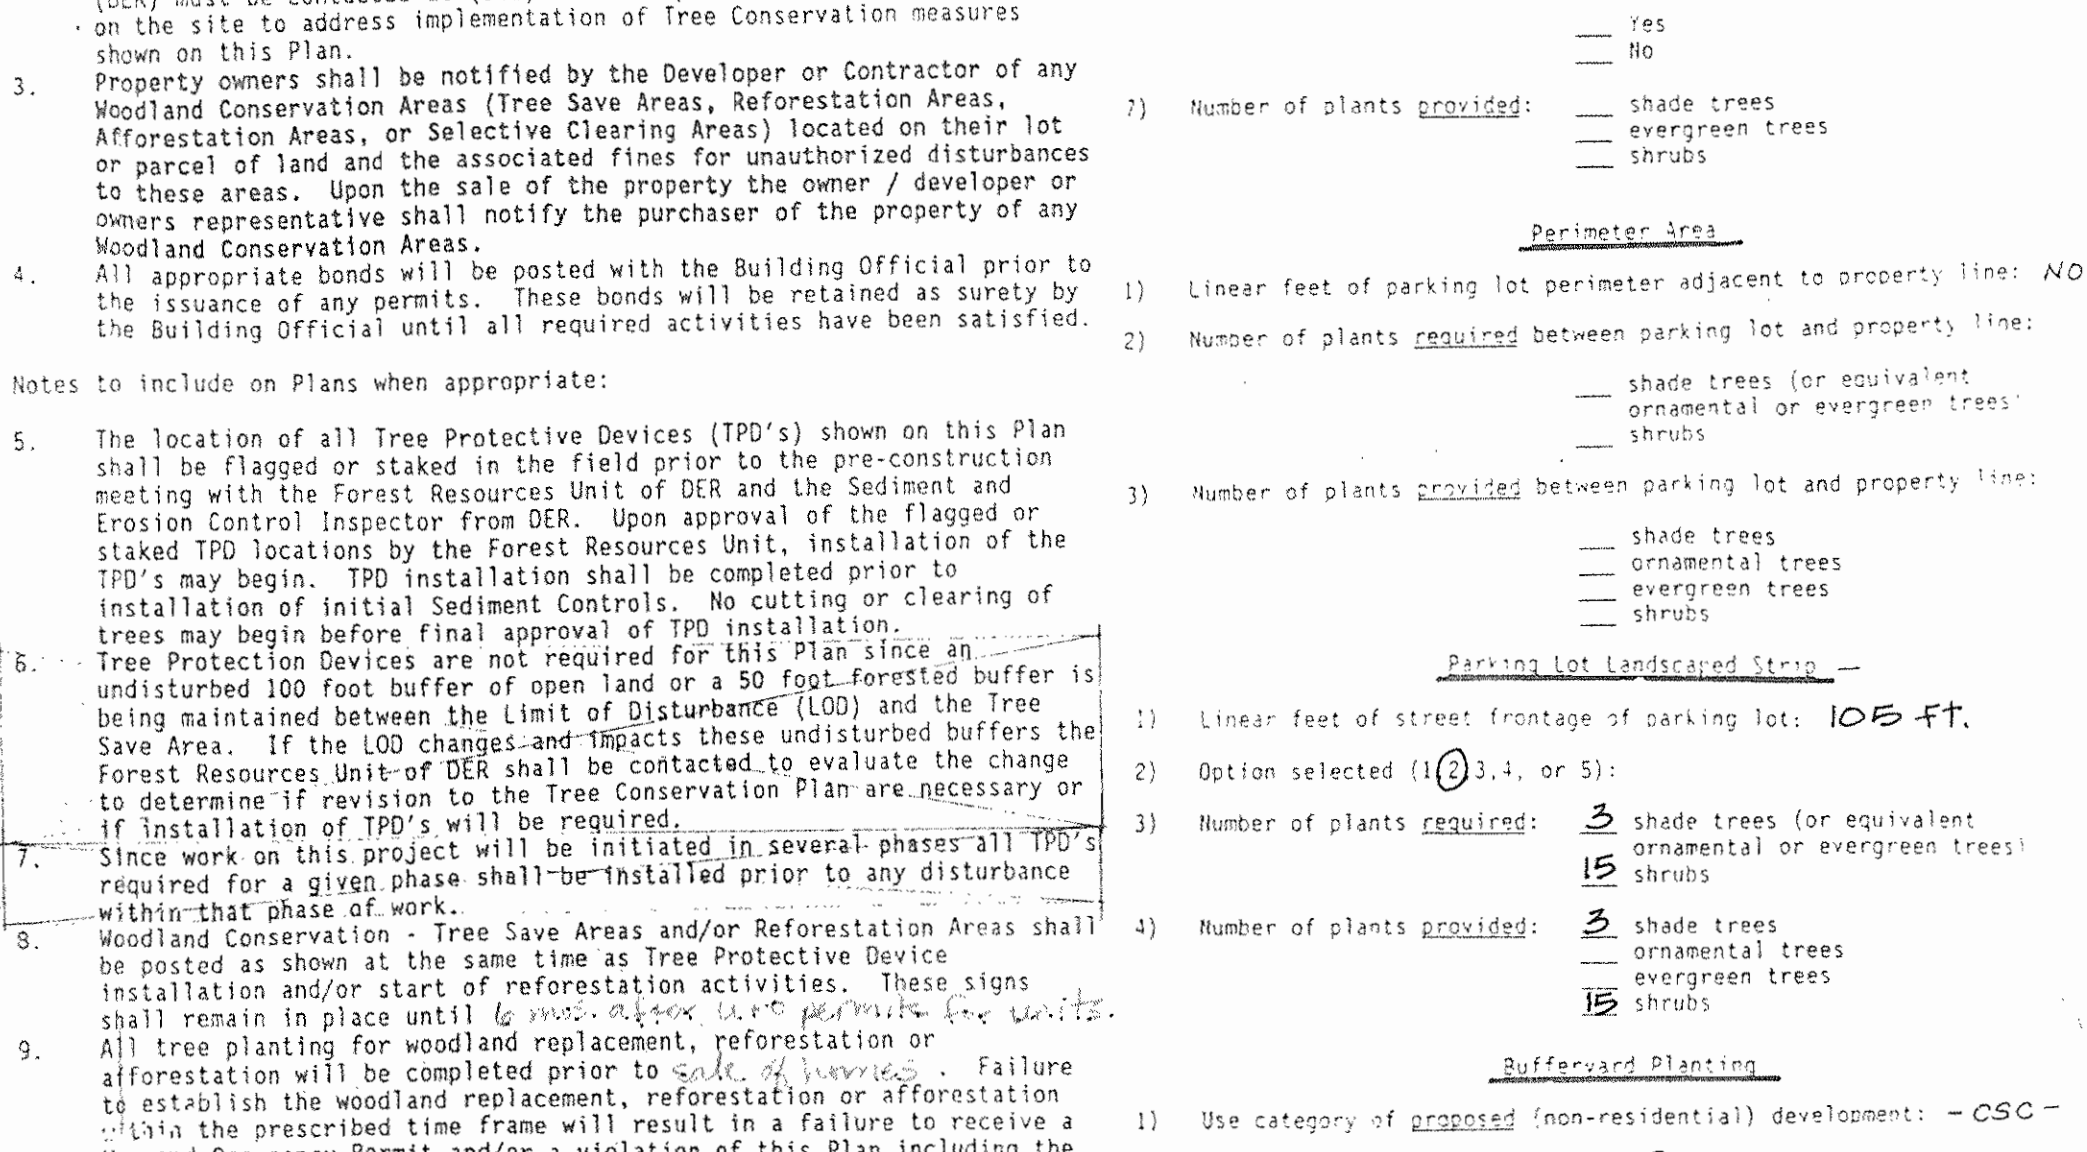[illegible]

BLAZE ORANGE PLASTIC MESH

(Number of these trees provided: 9 @ 10 p.u. = 90 p.u.
Number of evergreen trees: 6 @ 5 p.u. = 30 p.u.
Number of ornamental trees: 3 @ 5 p.u. = 15 p.u.
Number of shrubs: 3 @ 1 p.u. = 3 p.u.)

(3) Total number of plant units provided in buffer strip: 512

Plant Management Plan

- This plan is for a 5 year period until the reforestation is established.
- The maintenance program is as follows.
 - The area will be outlined by the tree protection for the five year period.
 - The area protected by the T.P.D. will be mowed a year to assure weed control and allow seedling chance to survive.
 - The H.O.A. will be responsible for tree care.
 - The final survival rate will be 75% of the total.

Year 1: tree planting
Survival check 3 times (March-April), (July-August), (October-November)
Watering if needed
Control of undesirable vegetation if needed
Year 2-3: Reinforcement planting if needed
Survival check twice annually (April-May), (September-October)
Control of undesirable vegetation if needed
Year 4-5: Reinforcement planting if needed
Survival check once annually (May-September)

ANCHOR POSTS SHOULD BE MINIMUM 2" STEEL X CHANNEL
USE 2" X 2" LAMBER 6' IN LENGTH

MINIMUM 8 FEET

2" X 4" LAMBER FOR CROSS BRACING

4 FEET MINIMUM

ANCHOR POSTS MUST BE ENCASED IN 2" X 4" LAMBER
NO LESS THAN 1/3 OF THE TOTAL HEIGHT OF POST

USE 2" X 4" LAMBER TO SECURE FRAME BOTTOM

NOTES:

- Formal protection device only.
- Maximum mesh width and an part of the frame project over the top of the tree canopy to be raised and stopped prior to installing device.
- Reinforcement planting should be done.
- Reinforcement planting should be done.
- Device should be monitored for damage and replaced.
- Device should be monitored for damage and replaced.

TREE PROTECTION T.P.D.

1. This plan is for a 5 year period until the reforest established.
2. The maintenance program is as follows.
 - a. The area will be outlined by the tree protection for the five year period.
 - b. The area protected by the T.P.D. will be moved a year to assure weed control and allow seedling chance to survive.
 - c. The H.O.A. will be responsible for tree care.
 - d. The final survival rate will be 75% of the total.


Year 1: tree planting
Survival check 3 times (March-April), (July-August), (October-November)
Watering if needed
Control of undesirable vegetation if needed

Years 2-3: Survival planting if needed
Survival check annually (April-May), (September-October)
Control of undesirable vegetation if needed

Years 4-5: Survival planting if needed
Survival check 2 times (May-September)

[illegible]

Prince George's County Planning Department, M-NCPPC Environmental Planning Section TYPE 2 TREE CONSERVATION PLAN APPROVAL TCP2 – 029-95				
	Approved by	Date	DRD #	Reason for Revision
00	H. Stacy Miller	6/30/95	DSP-95015	N/A
01	Jim Stasz	6/6/96	DSP-05107	For Parcels 2 and 3 only.
02		8/16/2017	4-16020	To remove Parcels A, 2, and 3 from the site.
03				
04				
05				

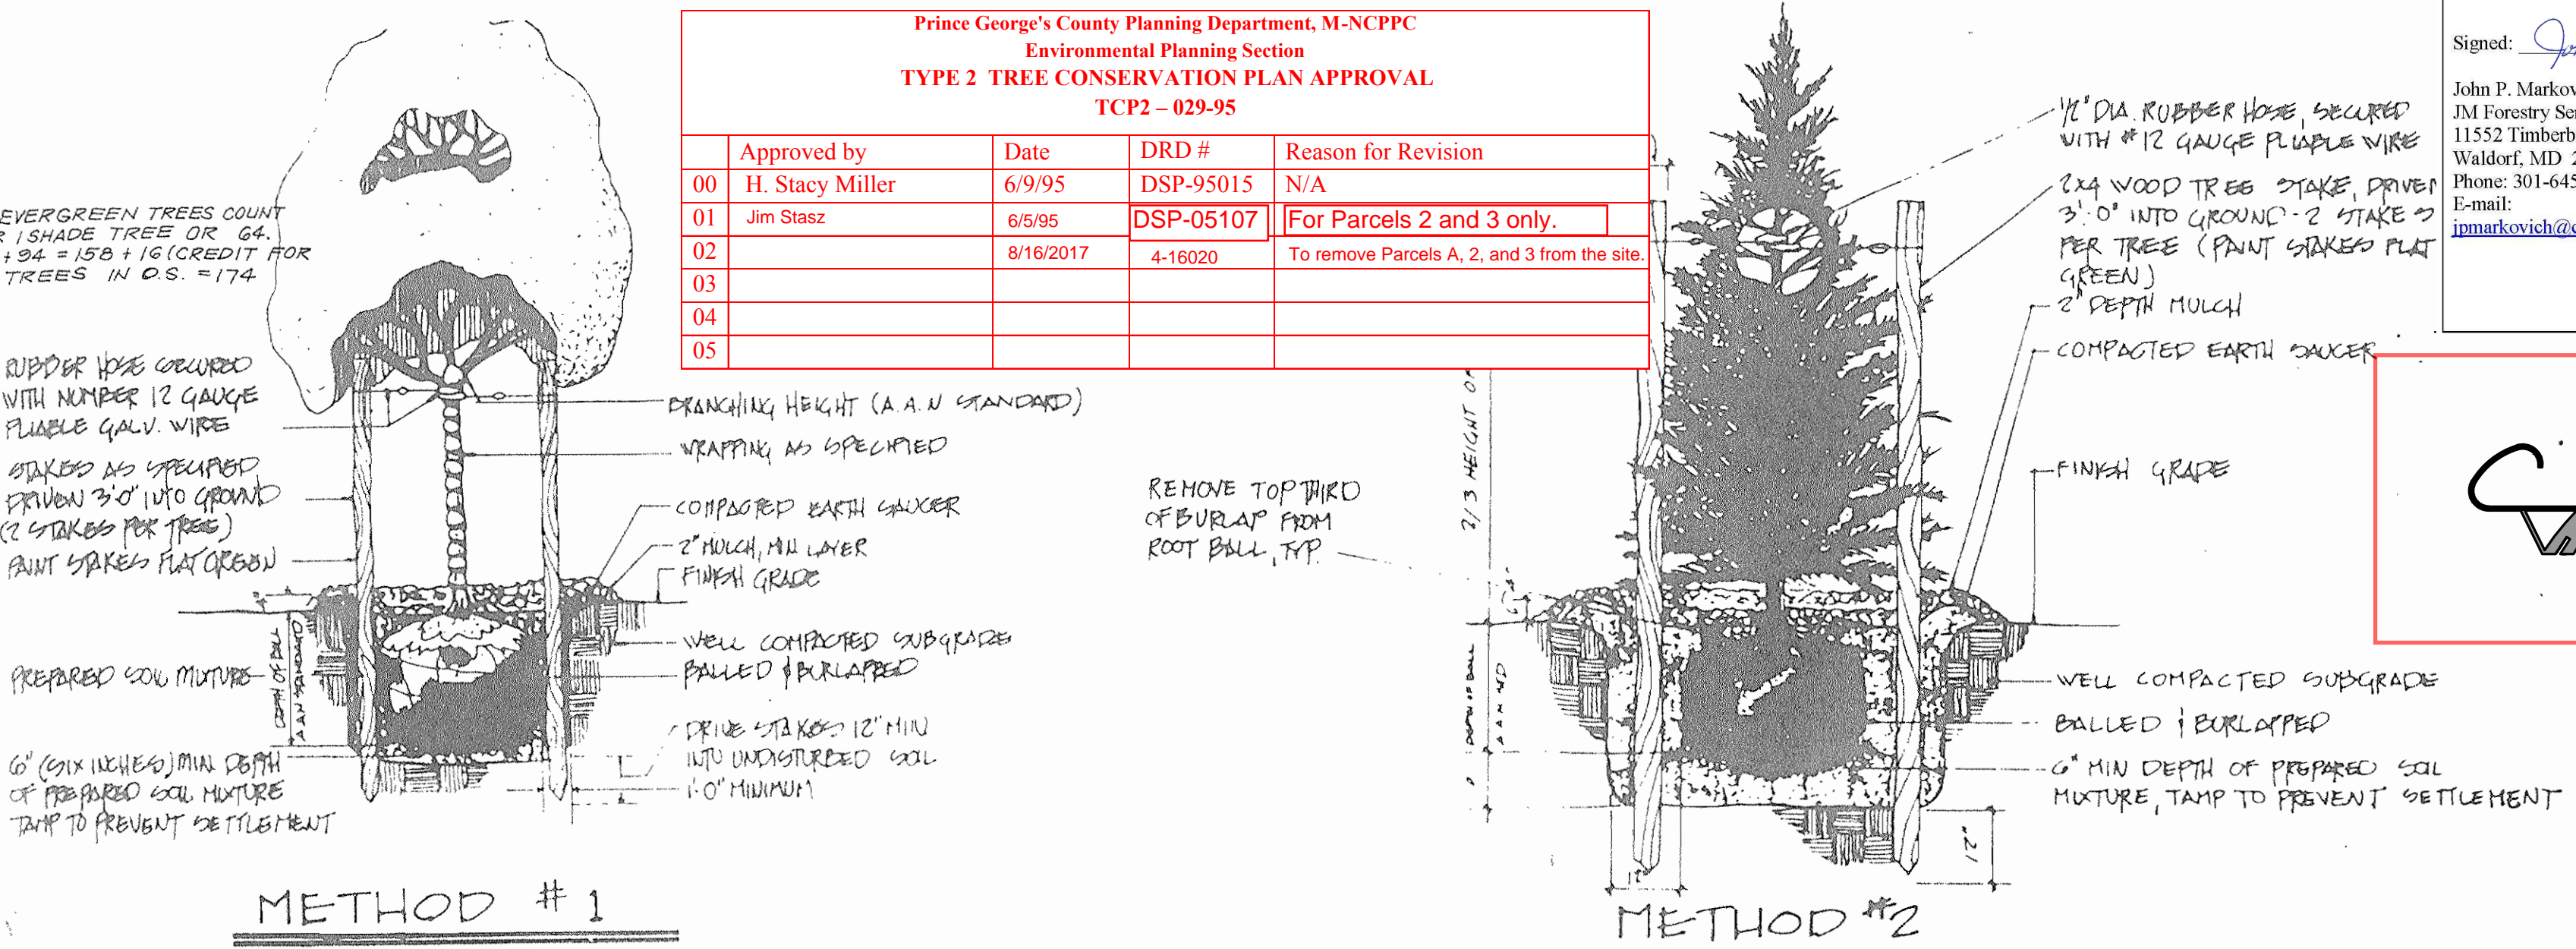

NOTE: GETTING ALL TREES - THE PIT SHALL BE EXCAVATED TO A DEPTH 50 ASD TO ASSURE THAT THE INTERSECTION OF TRUNK AND THE TOP OF ROOT BALL IS AT THE SAME ELEVATION OF THE ADJACENT FINISH GRADE.

Diagram illustrating the construction of a tree pit:

- 2' DEPTH MULT. PM
- COMPACTED EARTH COVER
- FINISH GRADE
- WELL COMPACTED SUB-GRADE
- PAVED & SLOPED
- 50" DEPTH OF PREPARED SOIL MIXTURE, TAMP TO PREVENT SETTLEMENT

METHOD #3

MULCH

MULCH

a a

$2a$

DEB

Mulching newly planted seedlings is suggested as it helps the soil retain moisture and it protects the seedling from compaction and stem injury.

Signed: John P. Markovich Date: 6/9/11
 John P. Markovich
 J1 Forestry Services, LLC
 11552 Timberbrook Drive
 Waldorf, MD 20601
 Phone: 301-645-4977
 E-mail:
j1markovich@comcast.net

CV, INC.
1395 PICCARD DRIVE, SUITE 370
ROCKVILLE, MARYLAND 20850
PHONE: (301) 637-2510
FAX: (240) 252-5612
CONTACT: CHINMAY VYAS, P.E.
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DETAIL OF BENCH

MODEL # 338 - 6' 0" - 4' ASP

The drawing consists of two parts. The main part is a 'BOARD FENCE ELEVATION' showing a section of a fence with three 8'-0" segments. It features a 2x4 stringer, 4x4 standard posts, 2x4 caps, 1x4 facia, and random pattern fence boards (1x5, 1x4, 1x5, 1x6). The total height is 5'-6" and the ground line is labeled 'FINISH GRADE'. A note specifies: 'NOTE TOP OF FENCE TO BE LEVEL. STEP FENCE AT POSTS W/CAPS.' The bottom part is a detail of a 'RAIL FENCE' showing a 10'-0" section with a 1 1/2" high rail fence installed 17' 1/2" from the walls. This detail is crossed out with a large red X.

BOARD FENCE ELEVATION

4x4 POST W/CAP SEE DETAIL THIS SHEET

RANDOM PATTERN FENCE BOARDS (1x5)(1x4)(1x5)(1x6)

2x4 STRINGER

4x4 STANDARD POST SEE DETAIL

2x4 CAP

1x4 FACIA

1x4 FACIA

2x4

5'-6"

8'-0"

8'-0"

8'-0"

FINISH GRADE

NOTE TOP OF FENCE TO BE LEVEL. STEP FENCE AT POSTS W/CAPS.

RAIL FENCE

10'-0"

1 1/2" HIGH RAIL FENCE

17' 1/2" OF WALLS.

M-NCPPC
Prince George's County Planning Department
Natural Resources Division
APPROVAL
TREE CONSERVATION PLAN
TOP- *11/14/15*
BY *11/14/15* DATE *11/14/15*

SHAFFER BATT & ASSOC., INC.
ENGINEERS-LAND PLANNERS-SURVEYORS
818 W. DIAMOND AVE., SUITE 100
GAITHERSBURG, MARYLAND 20878
(301) 417-0344

SCALE:
AS SHOWN
SHEET NO.
4 OF 5
DATE
NOVEMBER, 94
DRAWN BY:
D.G. LEANO

KEYSTONE

RETAINING WALL SYSTEMS

CREATIVITY Variations in color, face pattern and angle, along with two modular sizes, make the KeyStone™ System a designer's dream.

DURABILITY The KeyStone™ System features high-strength concrete modules that interlock and are reinforced with steel mesh, so non-deteriorating materials provide a lifetime of performance.

REAL APPEARANCE The heavy textures and the deep shadows of the KeyStone™ System create a pleasing appearance that blends and harmonizes with the surroundings.

EASE OF INSTALLATION The KeyStone™ System can be installed in half the time as other walls with semi-skilled personnel. No footings or foundations are required.

COST EFFECTIVE Mass production allows the KeyStone™ to pass its savings on to you. This combined with Durability and Ease of installation makes the KeyStone™ System the most cost-effective choice.

